# CITY OF MADISON

# STATE STREET CAPITOL GARAGE GENERATOR REPLACEMENT CITY OF MADISON CONTRACT NO.9131

214 N Carroll St Madison, WI 53703

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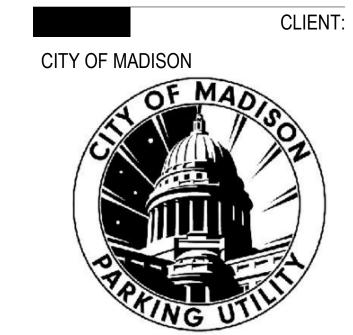
### **EXISTING PROJECT CONDITIONS**

INFORMATION PERTAINING TO EXISTING PROJECT CONDITIONS, SUCH AS LOCATIONS OF ARCHITECTURAL AND STRUCTURAL BUILDING COMPONENTS, MECHANICAL AND ELECTRICAL EQUIPMENT, PIPING, DUCTWORK, ROUGH-INS AND OTHER MISCELLANEOUS CONSTRUCTION APPEARS ON PROJECT DRAWINGS. THIS INFORMATION IS BASED ON AVAILABLE RECORDS AS WELL AS INFORMATION COLLECTED WITH REASONABLE CARE AT THE PROJECT SITE. CONTRACTORS SHALL BE SOLELY RESPONSIBLE FOR VERIFYING DIMENSIONS AND RELATED INFORMATION AT THE PROJECT SITE PRIOR TO PROCURING ANY MATERIALS, PRODUCTS OR EQUIPMENT TO PERFORM THEIR WORK.

GREF

275 West Wisconsin Avenue, Suite 300 Milwaukee. WI 53203 414 / 259 1500 414 / 259 0037 fax

www.graef-usa.com



215 Martin Luther King Blvd

Madison, Wisconsin 53703

PROJECT TITLE:

STATE STREET CAPITOL GARAGE GENERATOR REPLACEMENT

214 N Carroll St Madison, WI 53703

BIDDIN 11/05/2021 REVIEW SET 12/23/2021 PERMIT SET

PROJECT INFORMATION

**EKS** 

CWH

PROJECT NUMBER: 2021-5004 DATE: 12/23/2021

DRAWN BY:

CHECKED BY: CWH APPROVED BY:

AS NOTED SCALE:

> SHEET TITLE: TITLE SHEET

SHEET NUMBER

G-001

### FIRE EXTINGUISHER KEY:

FOR FIRE EXTINGUISHERS < 40LBS:

• TOP OF FIRE EXTINGUISHER SHALL NOT EXCEED MORE THAN 5'-0" ABOVE FINISH FLOOR. • BOTTOM OF FIRE EXTINGUISHER SHALL BE 4" MINIMUM ABOVE FINISH FLOOR.

FOR FIRE EXTINGUISHERS ≥ 40LBS:

• TOP OF FIRE EXTINGUISHER SHALL NOT EXCEED MORE THAN 3'-6" ABOVE FINISH FLOOR. • BOTTOM OF FIRE EXTINGUISHER SHALL BE 4" MINIMUM ABOVE FINISH FLOOR.

FOR FIRE EXTINGUISHER CABINETS AND ADA COMPLIANCE: • CENTER CABINET PULL MAXIMUM 48" ABOVE FINISH FLOOR.

• MAXIMUM 4" PROJECTION FOR SEMI-RECESSED WALL CABINETS. REFER TO ICC A117.1-2009, OSHA 29 CFR 1910.157 AND NFPA-10 FOR ADDITIONAL INFORMATION.

FE-1 NEW CLASS A (ORDINARY COMBUSTIBLES) WALL MOUNTED FIRE EXTINGUISHER.

FE-2 NEW CLASS B (FLAMMABLE LIQUIDS) WALL MOUNTED FIRE EXTINGUISHER.

FE-3 NEW CLASS C (ELECTRICAL EQUIPMENT) WALL MOUNTED FIRE EXTINGUISHER.

FE-4 NEW CLASS D (FLAMMABLE METALS) WALL MOUNTED FIRE EXTINGUISHER. FE-5 NEW CLASS K (COOKING FIRES) WALL MOUNTED FIRE EXTINGUISHER.

FE-6 NEW CLASS ABC (MULTI-PURPOSE) WALL MOUNTED FIRE EXTINGUISHER.

LIST OF ABBREVIATIONS AC - ACOUSTIC HM - HOLLOW METAL - ACOUSTICAL TILE CEILING MP - METAL PANEL - ABOVE FINISHED FLOOR MTL - METAL - NAPKIN DISPOSAL ALUM - ALUMINUM OC - ON CENTER BRG PT - PAINT - BEARING - PREFINISHED CMU - CONCRETE MASONRY UNIT RD - ROOF DRAIN CONC - CONCRETE RTU - ROOF TOP UNIT - CONTROL JOINT - STAIN AND VARNISH CO SCHD - SCHEDULE SD - SOAP DISPENSER EPX - EPOXY STL - STEEL EQ - EQUAL TD - TOWEL DISPENSER ES - EXPOSED STRUCTURE TO - TOP OF EXIST - EXISTING TOE - TOP OF EXISTING TP - TOILET PAPER - FIRE EXTINGUISHER V - VARNISH FEC - FIRE EXTINGUISHER CABINET VB - VINYL BASE - FIELD VERIFY VCT - VINYL COMPOSITE TILE VFGT - VINYL FACED GYPSUM TILE - GYPSUM BOARD WD - WOOD - GLASS WND WR - WASTE RECEPTACLE

### **BUILDING CODE DATA:**

**APPLICABLE CODE RESOURCE:** WISCONSIN COMMERCIAL BUILDING CODE (BASED ON 2015 IBC)

PRIMARY OCCUPANCY: IBC chapter 3 GROUP: S-2 SECONDARY OCCUPANCY: IBC chapter 3 GROUP: N/A FIRE WALL(S) REQUIRED: IBC section 706

☐ NO ☒ YES 2 HOUR FIRE BARRIER(S) REQUIRED: IBC section 707 □ NO 
▼ YES 2 HOUR

CLASSIFICATION OF CONSTRUCTION: IBC chapter 6

**SPRINKLER SYSTEM:** YES NFPA 13 □

NOTES: THIS PROJECT IS A LEVEL 2 ALTERATION, PER THE 2015 INTERNATIONAL EXISTING BUILDING

CODE (IEBC) • ALL AREAS BEYOND THE PROJECT LIMIT, AS DEFINED WITHIN THESE DRAWINGS. IS NOT IN SCOPE FOR THIS PROJECT AND HAS NOT BEEN

**EVALUATED FOR COMPLIANCE WITH** APPLICABLE BUILDING CODES. THIS PARKING STRUCTURE DOES NOT CONTAIN ANY TOILET ROOMS, AS PERMITTED

BY CODE.

### **DESIGN SPECIFICATIONS**

- MINIMUM 28 DAY CONCRETE CYLINDER STRENGTH SHALL BE 3500 PSI
- REINFORCING STEEL SHALL CONFORM TO ASTM A615 GRADE 60.
- CONCRETE MASONRY UNITS SHALL CONFORM TO ASTM C90 LIGHTWEIGHT UNITS. MINIMUM COMPRESSIVE STRENGTH OF CONCRETE MASONRY UNITS.
- MORTAR SHALL CONFORM TO ASTM C270 TYPE S
- STRUCTURAL STEEL PLATES, ANGLES, CHANNELS, AND OTHER ROLLED MEMBERS SHALL CONFORM TO ASTM A36,  $F_v = 36$  KSI.
- CONTRACTOR IS RESPONSIBLE FOR MEANS AND METHODS OF CONSTRUCTION AND JOB SITE

### CONCRETE

- CONCRETE PROTECTION FOR REINFORCING BARS SHALL BE IN ACCORDANCE WITH THE "BUILDING CODE REQUIREMENTS FOR STRUCTURAL CONCRETE", ACI 318-14.
- EXTERIOR EXPOSED CONCRETE SHALL BE AIR-ENTRAINED. AIR CONTENT SHALL BE 6 PERCENT

### **CONCRETE MASONRY**

- CONCRETE MASONRY WALLS SHALL BE REINFORCED AT EVERY OTHER BED JOINT WITH [ ] 9 GAGE LADDER TYPE JOINT REINFORCEMENT.
- VERTICAL BARS SHOWN ON THE DESIGN DRAWINGS SHALL BE PLACED IN A CONTINUOUS UNOBSTRUCTED CMU CELL OF NOT LESS THAN 3 INCHES BY 4 INCHES.
- ALL DOOR AND WINDOW JAMBS SHALL BE GROUTED SOLID 8 INCHES WIDE UNLESS SHOWN

### STRUCTURAL STEEL


- ALL WELDING SHALL COMPLY WITH AWS D1.1 USING E70XX ELECTRODES. ALL WELDING TO BE DONE BY AWS PREQUALIFIED WELDERS, CERTIFIED FOR WELDS MADE. PROVIDE CONTINUOUS MINIMUM SIZED WELDS PER AISC REQUIREMENTS, UNLESS NOTED OTHERWISE.
- · ALL STRUCTURAL STEEL SHALL BE HOT-DIPPED GALVANIZED IN ACCORDANCE WITH ASTM A123, UNLESS OTHERWISE NOTED.

- · VERIFY AND COORDINATE, WITH ALL CONTRACTORS, THE LOCATION OF ALL ARCHITECTURAL
- EXPANSION ANCHORS SHALL BE HILTI KWIK BOLT TZ OR APPROVED EQUAL

### **MISCELLANEOUS**

- DIMENSIONS OF EXISTING CONSTRUCTION OR CONSTRUCTION IN PROGRESS SHALL BE VERIFIED. AND COORDINATED PRIOR TO FABRICATION OF STRUCTURAL COMPONENTS.
- AND MECHANICAL APPURTENANCES AND OPENINGS.
- ADHESIVE ANCHORS SHALL BE HILTI HIT-HY 200.
- CONTRACTOR SHALL PROVIDE SHOP DRAWINGS FOR THE STRUCTURAL STEEL PRIOR TO FABRICATION.

		SYMBOLS	LEGEND			
LINE		MATERIAL	REFERENCE			
	BEYOND	ALUMINUM	N			BREAK LINE
	BATT INSULATION	BRICK		NORTH INDICATOR		SPAN DIRECTION INDICATOR
	CENTER, GRID	CONCRETE	A3 A-501	DETAIL VIEW INDICATOR	×	OPENING (FLOOR, ROOF OR WALL)
	DEMOLITION	CONONLIE	A1			OK WALL)
	EXISTING (HALFTONE)	CONCRETE MASONRY BLOCK	D1 A-301 B1	ELEVATION VIEW INDICATOR	TOC 100'-0"	ELEVATION INDICATOR
	HIDDEN	EARTH	C1		1	KEYED NOTE INDICATOR
	MATCHLINE	GRAVEL	A1 A-001	SECTION VIEW INDICATOR	1	KEYED NOTE INDICATOR
	NEW (CUT)	DRY WALL, GROUT	A1/A-001	VIEW INDICATOR	$\langle \hat{1} \rangle$	WALL TYPE INDICATOR
	NEW (PROJECTION)	WOOD	1	GRID INDICATOR		REVISION CLOUD
	OVERHEAD	STEEL	1	EXISTING GRID INDICATOR	<u> </u>	REVISION INDICATOR

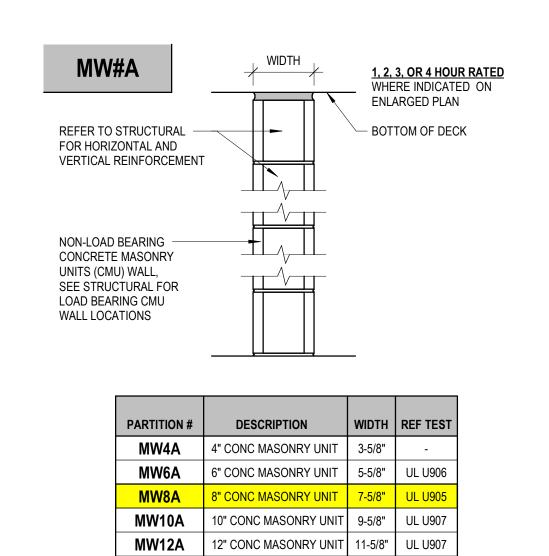

WALL TYPE

C1	C2	C3	C4	C5	
B1	B2	В3	B4	B5	
A1	A2	A3	A4	A5	

VIEW LOCATION LEGEND

1 1/2" = 1'-0"

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CWH CHECKED BY:

CWH APPROVED BY:


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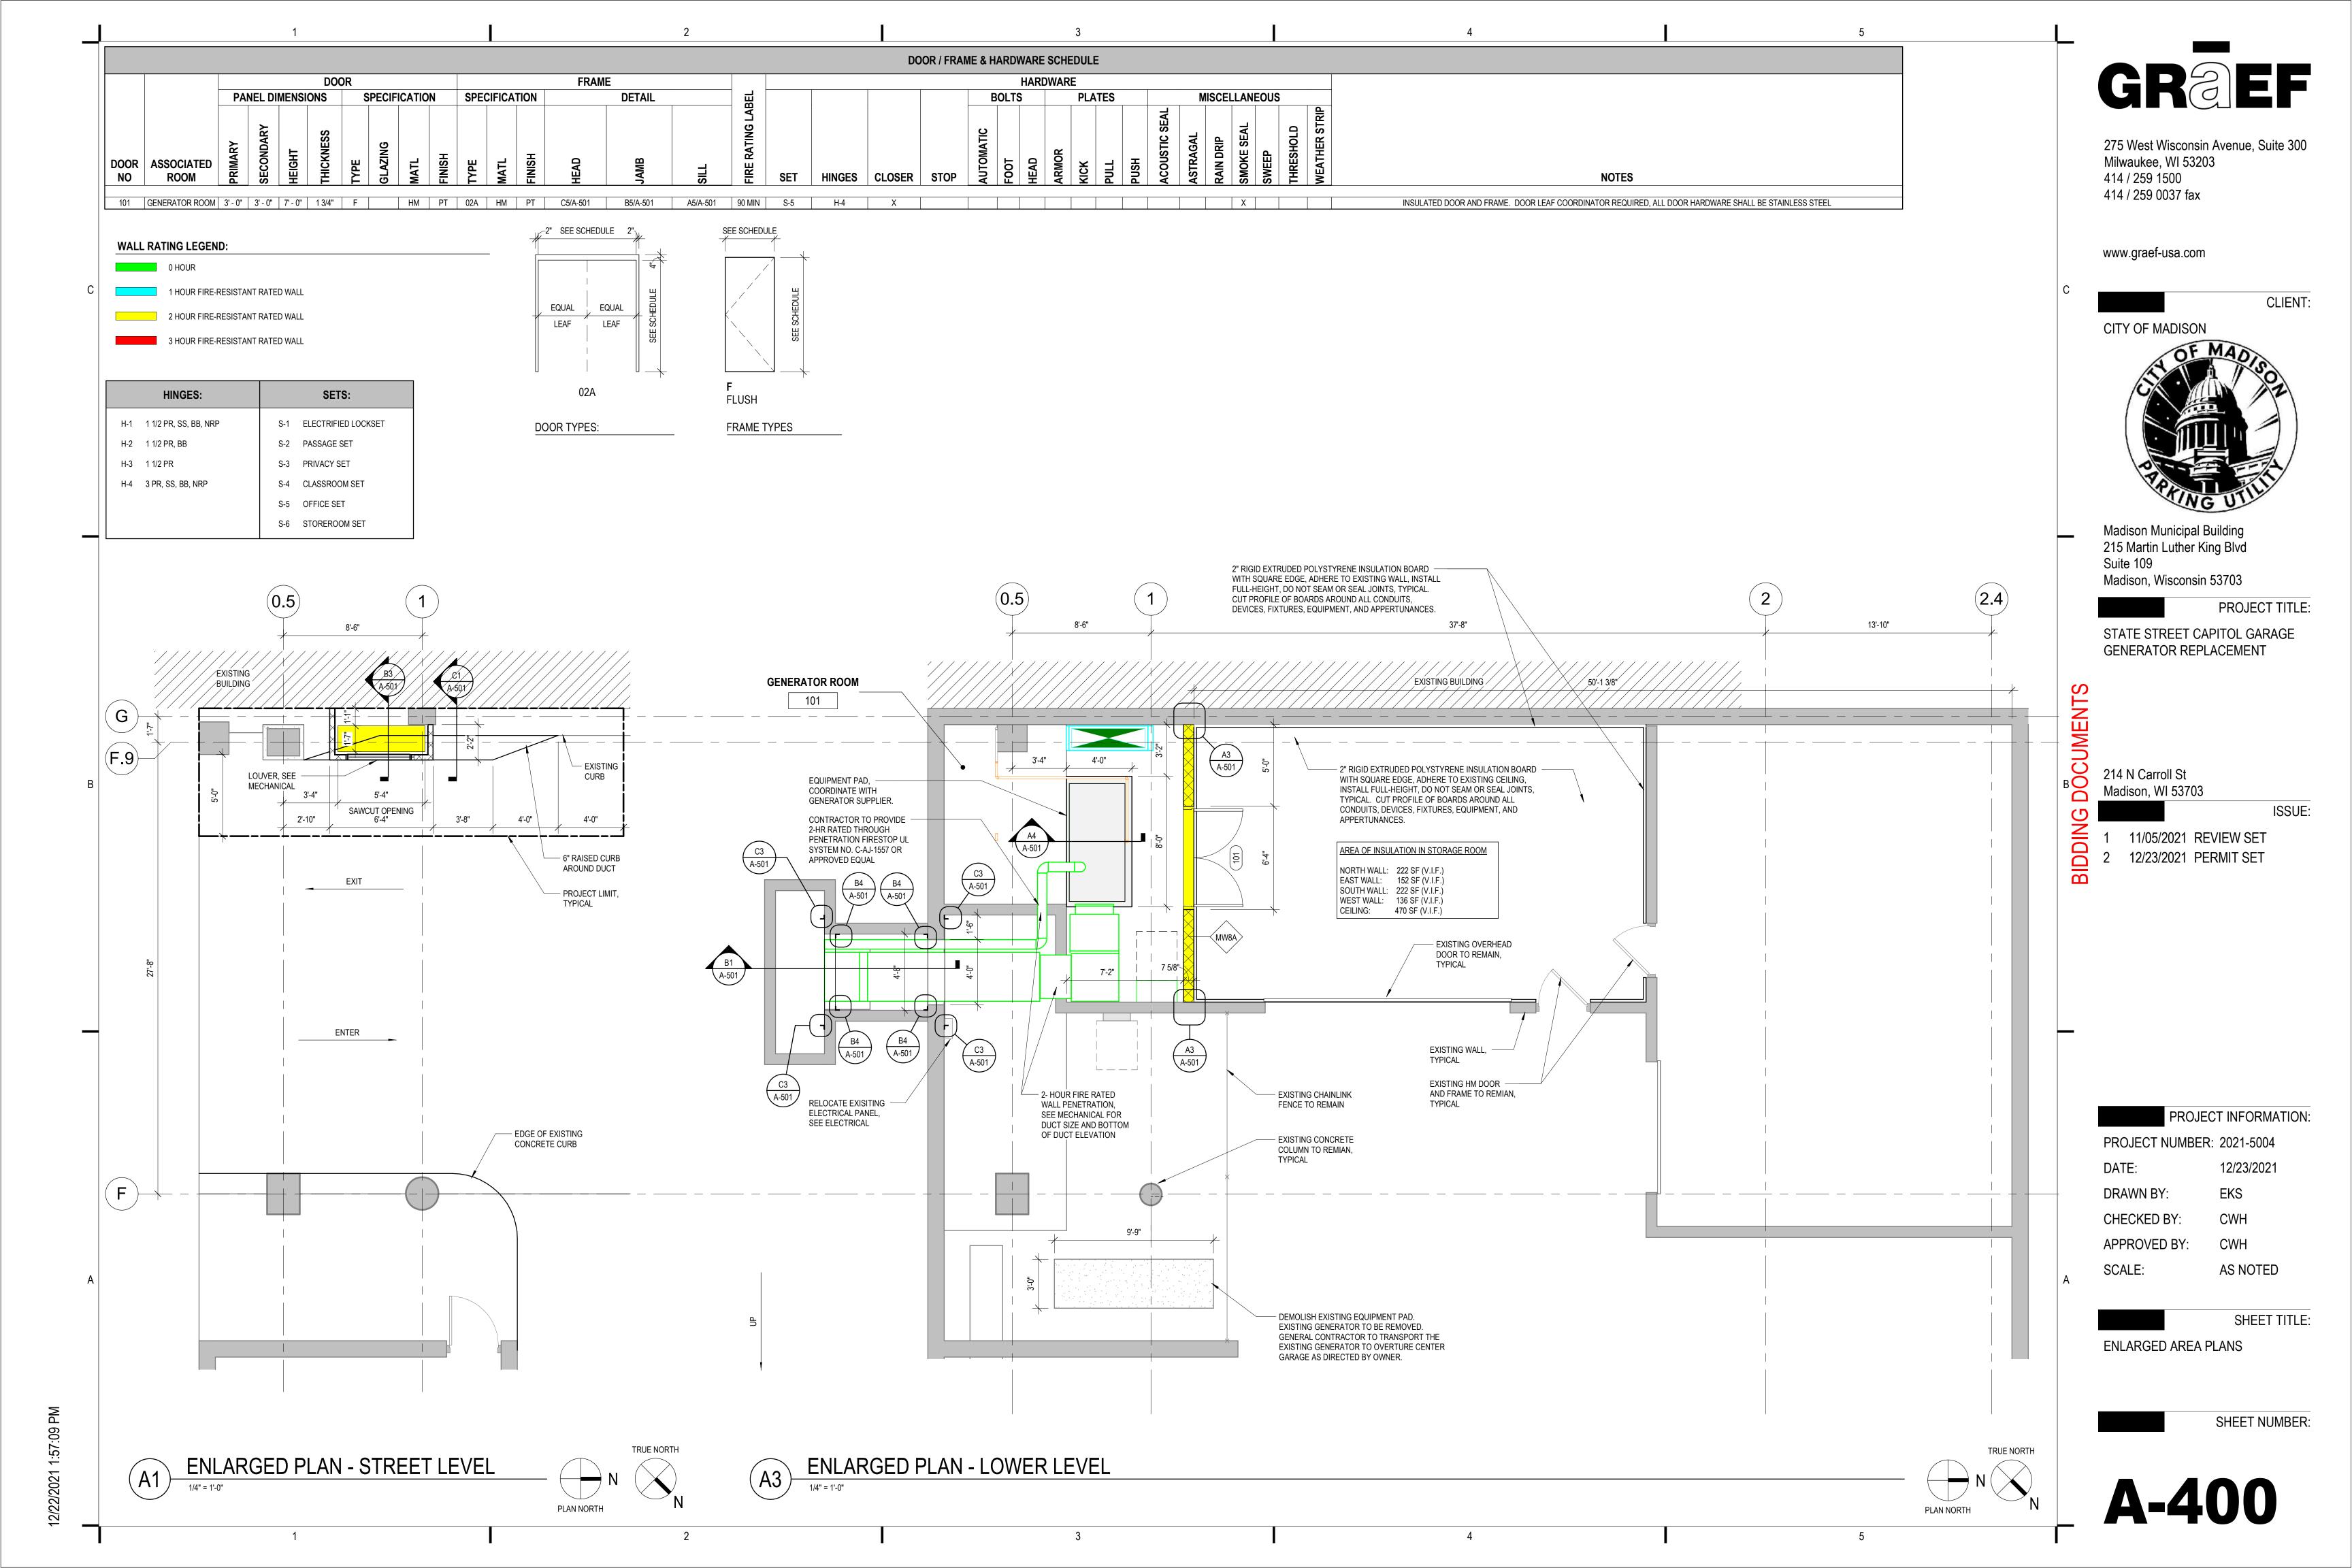
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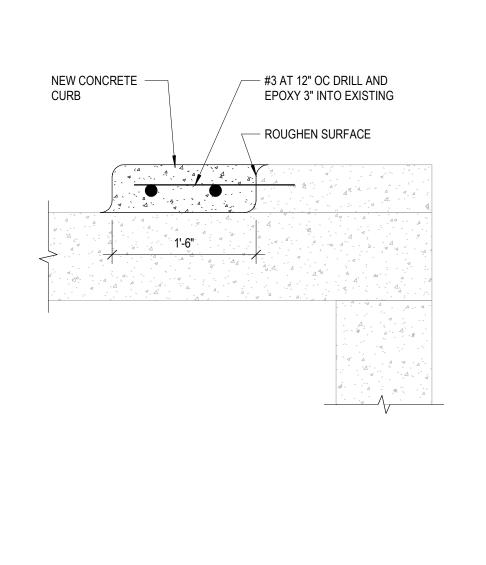
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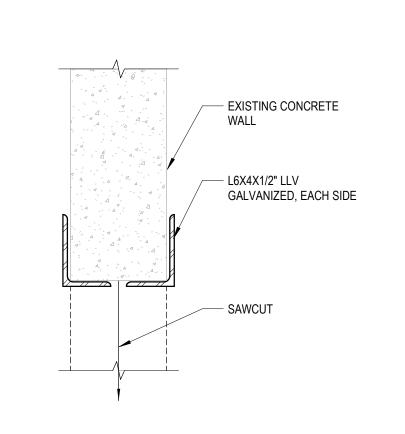
OVERALL PLAN - LOWER LEVEL


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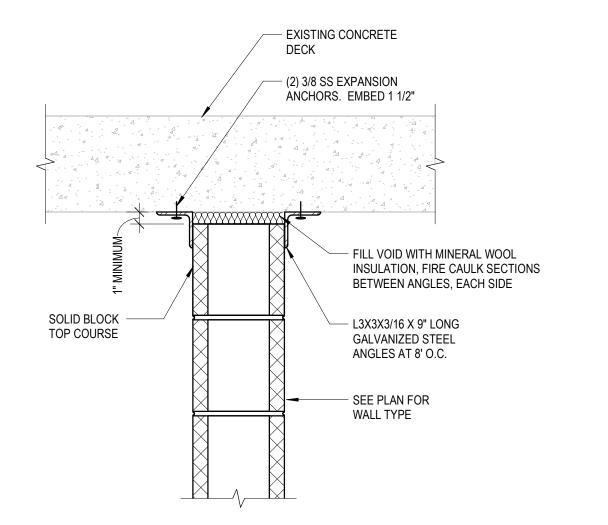
A-101









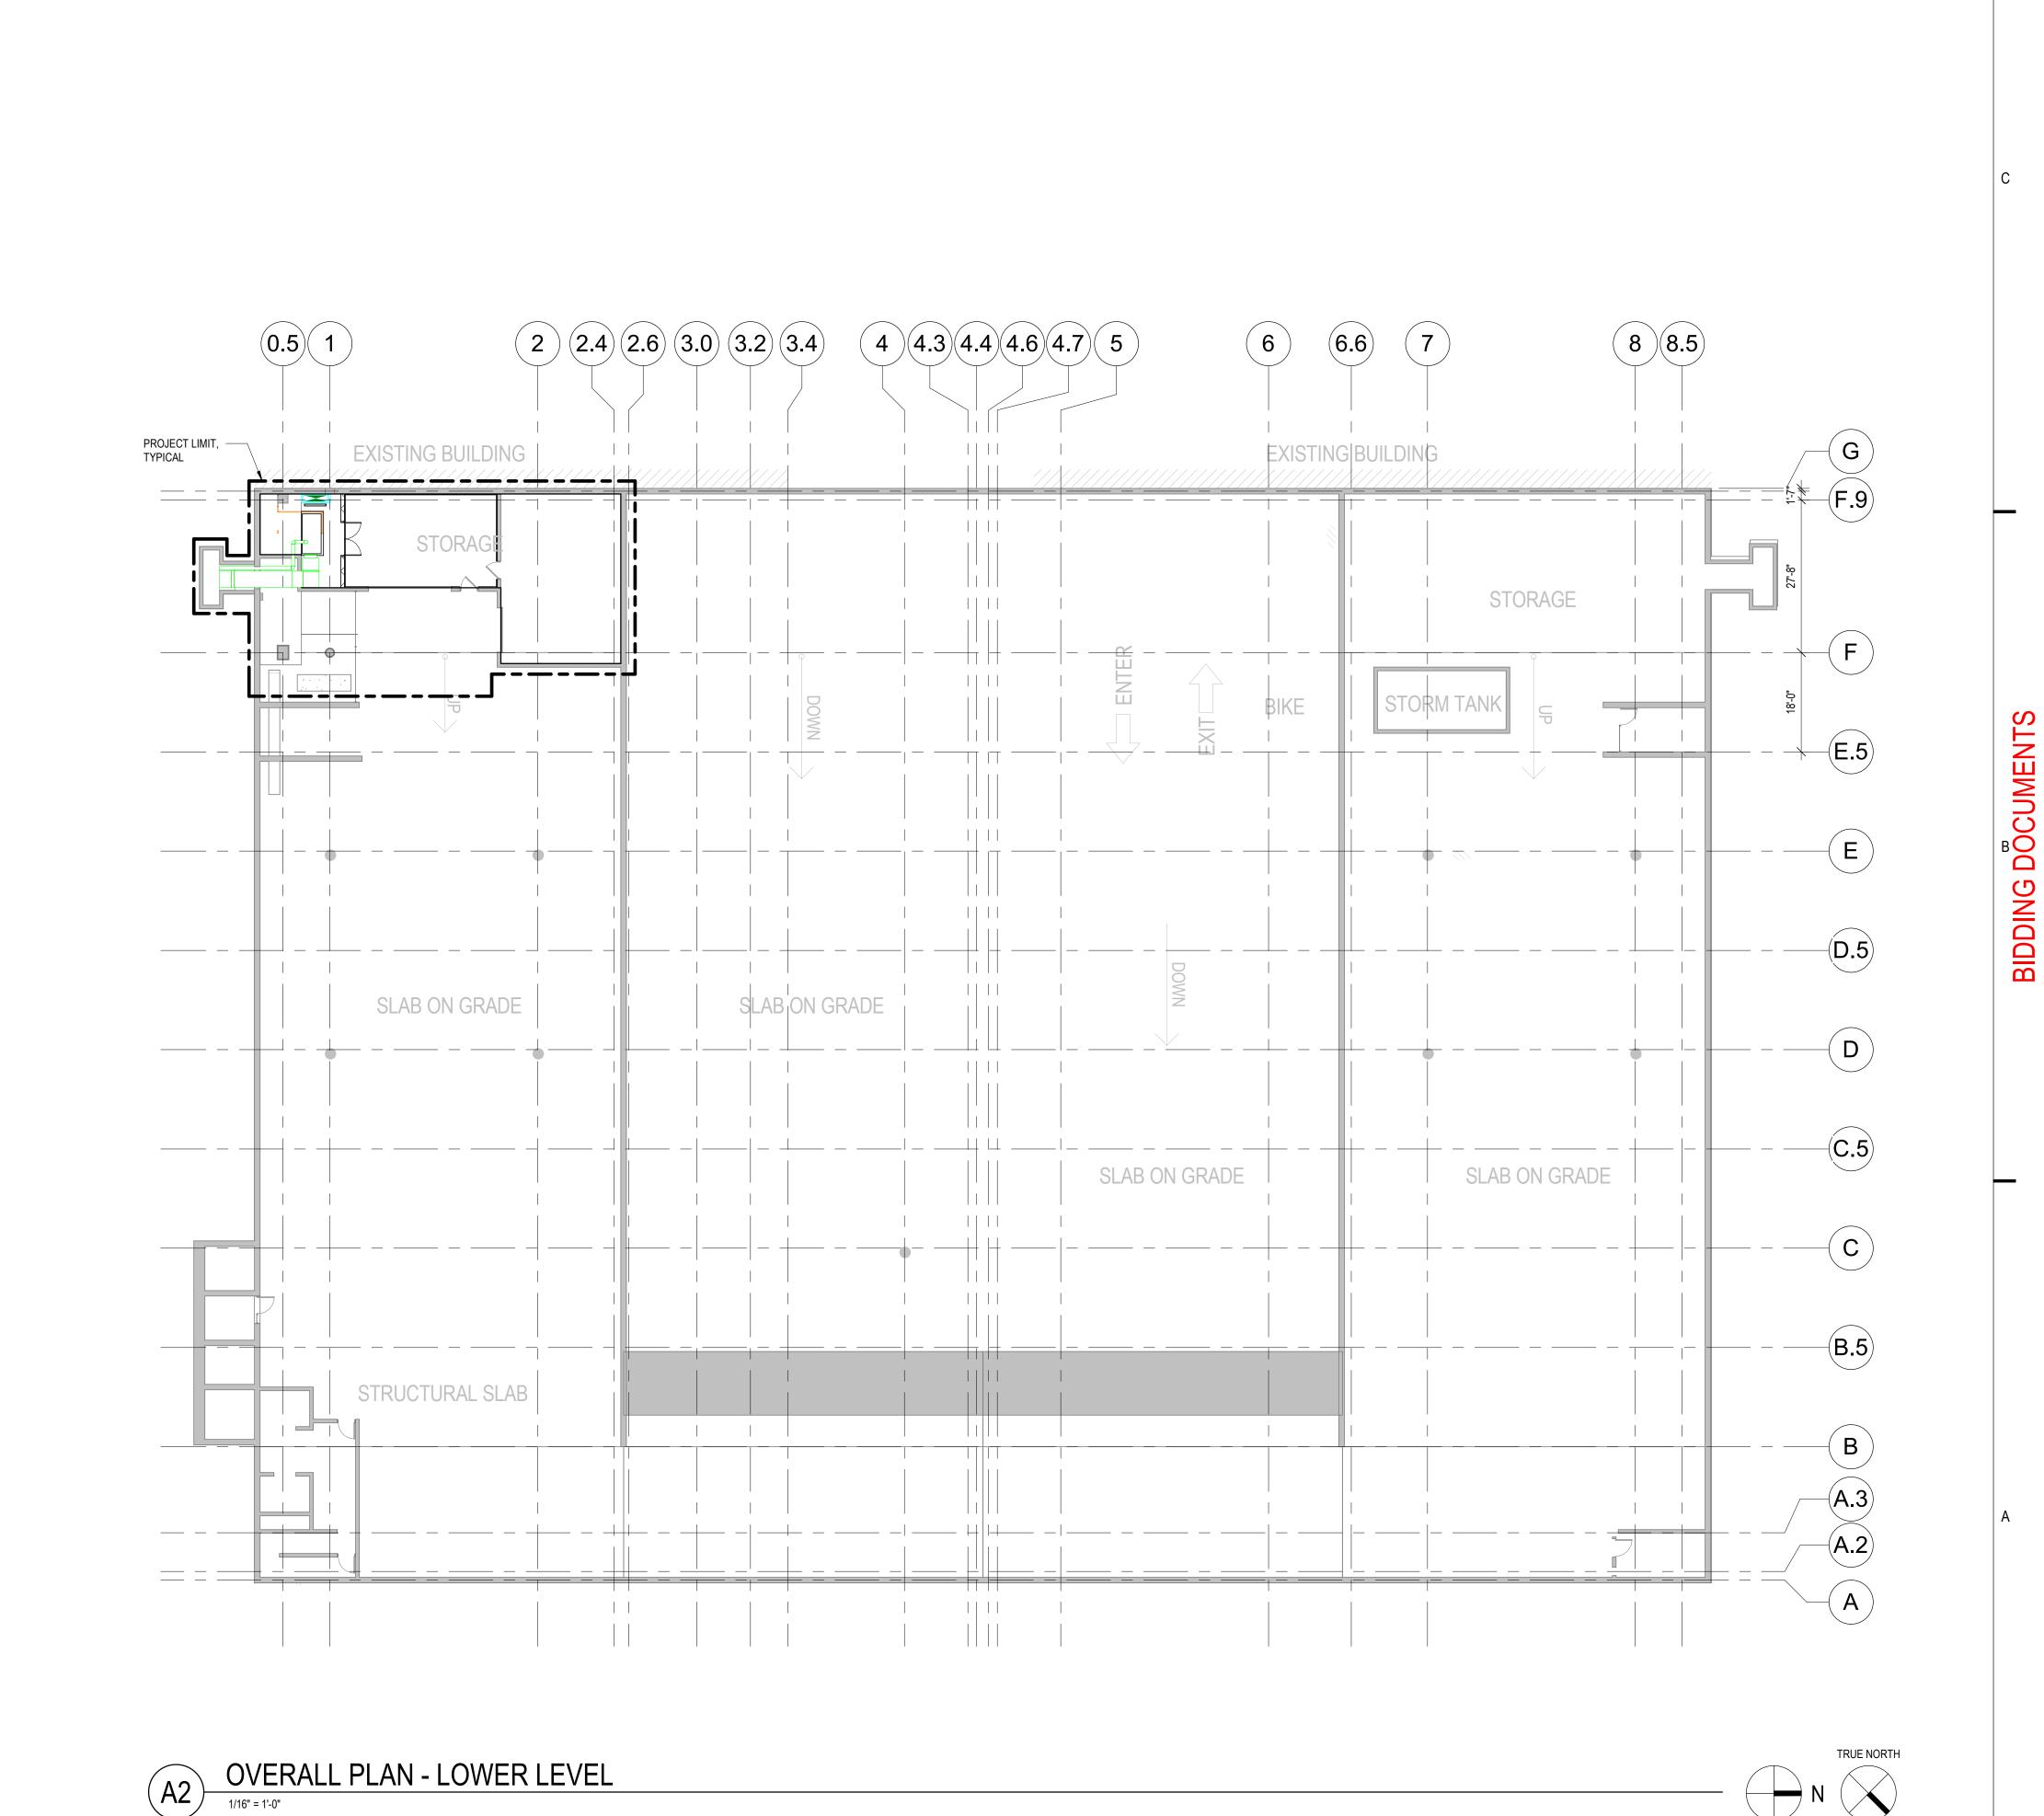

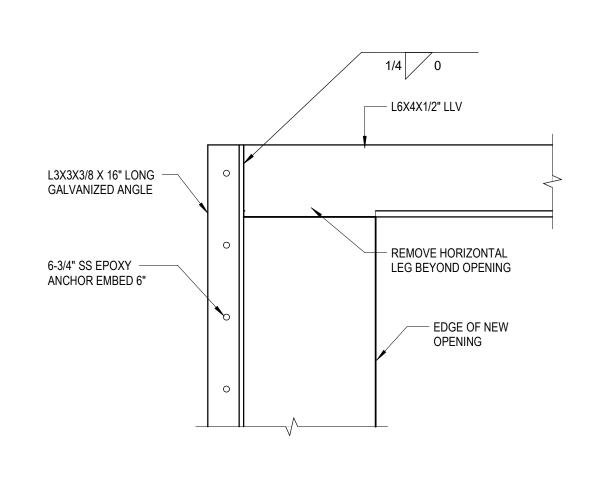


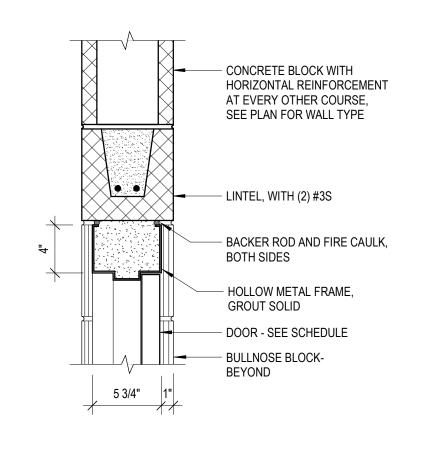

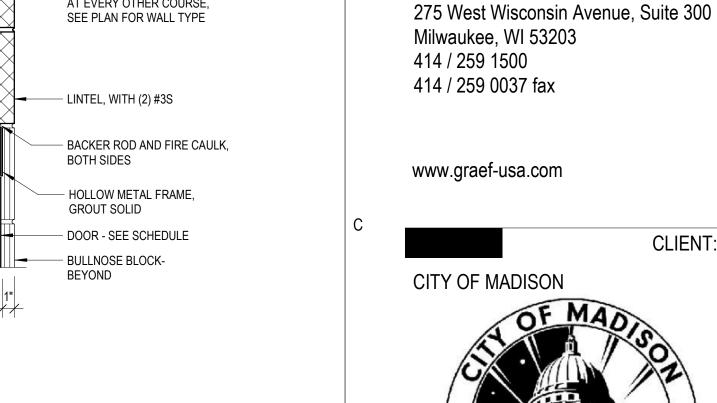




DETAIL AT LINTEL

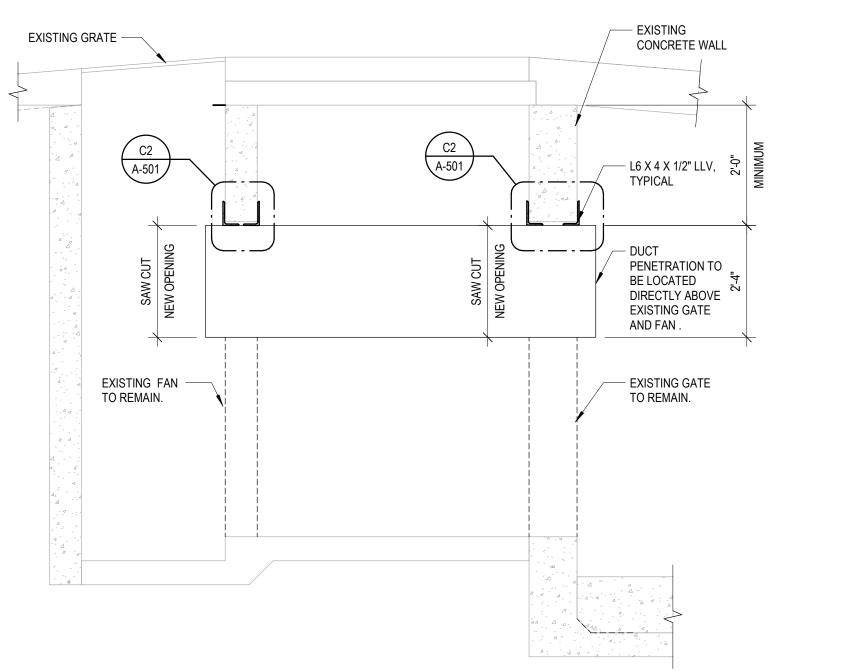



LINTEL CONNECTION DETAIL AT PARALLEL WALL

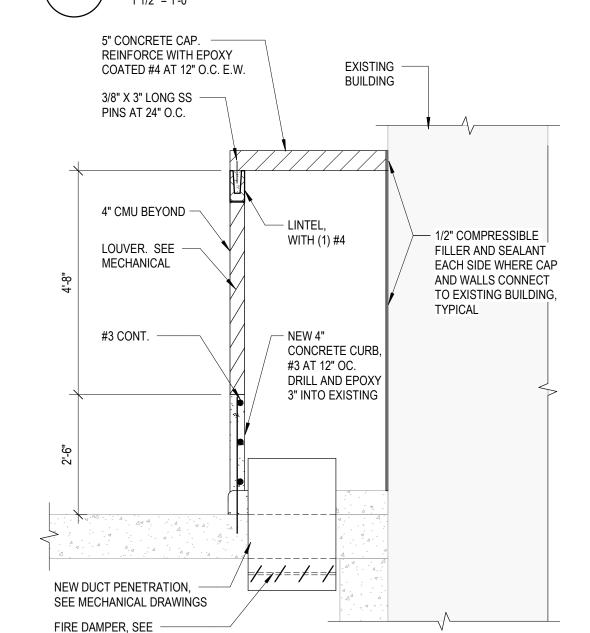



TOP OF WALL DETAIL



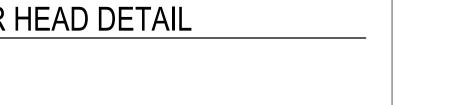

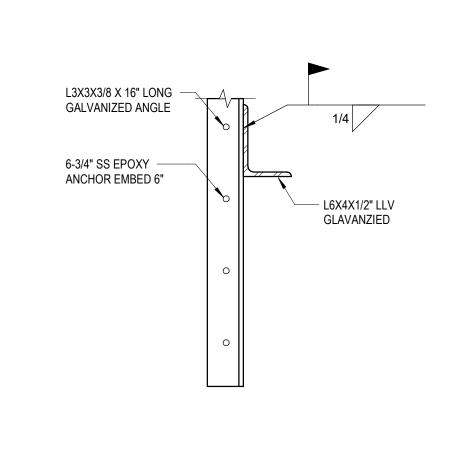

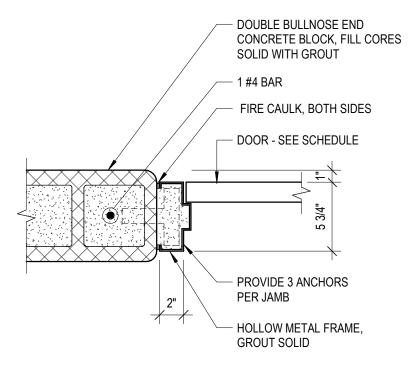

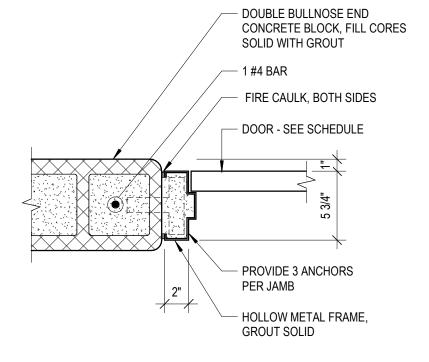



# SECTION AT EXISTING AREA WELL

**DUCT PENETRATION** 


MECHANICAL DRAWINGS




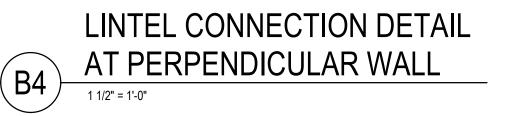


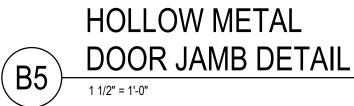



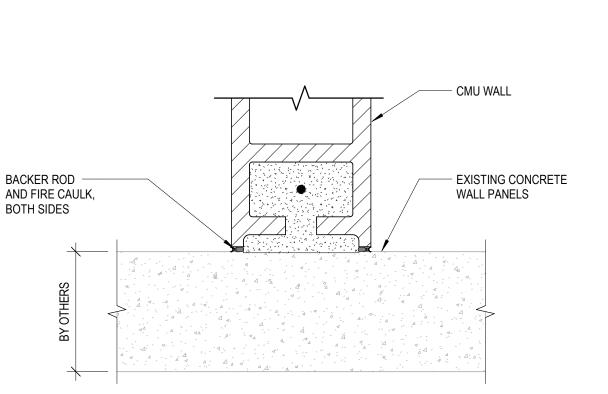

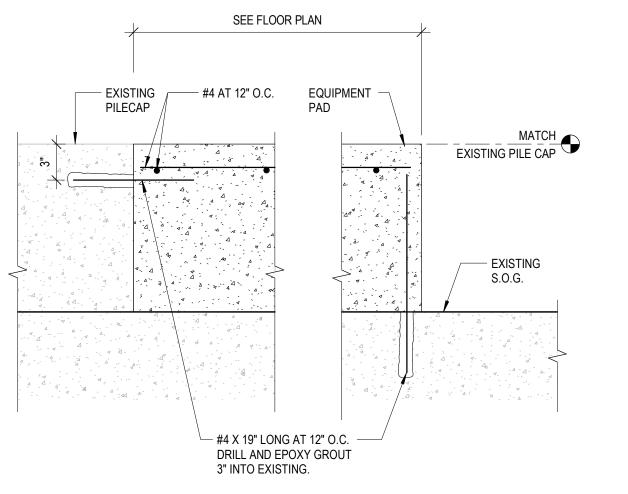

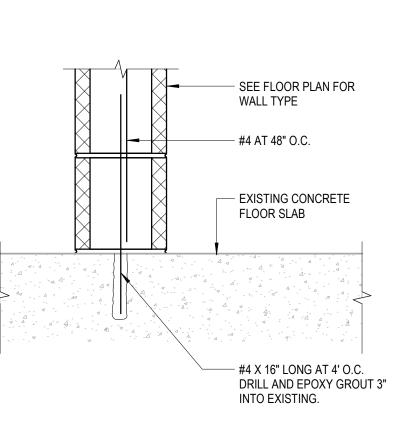

CMU TO EXISTING CONCRETE 1 1/2" = 1'-0"

DETAIL AT NEW GENERATOR PAD (A4)

INTERIOR CONCRETE **BLOCK WALL BASE DETAIL** (A5)1 1/2" = 1'-0"

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APPROVED BY: CWH AS NOTED

SCALE:

SHEET TITLE: **DETAILS** 

SHEET NUMBER:

**A-501** 

### MECHANICAL SYMBOLS AND ABBREVIATIONS

## NOTE: NOT ALL SYMBOLS AND ABBREVIATIONS INDICATED HERE ARE USED IN THE DRAWINGS AND MAY NOT APPLY TO THIS PROJECT. ADDITIONAL SYMBOLS MAY BE INDICATED IN THE DRAWINGS.

	MECHANICAL	ABBREVIA	ATIONS
AC ACC ACCU	<ul> <li>AIR CONDITIONING UNIT/AIR COMPRESSOR</li> <li>AIR COOLED CONDENSER</li> <li>AIR COOLED CONDENSING UNIT</li> </ul>	LAT LB/HR LF	<ul><li>LEAVING AIR TEMPERATURE</li><li>POUNDS PER HOUR</li><li>LINEAR FEET</li></ul>
ACU AD	- AIR CONDITIONING UNIT - ACCESS DOOR	LP LTG	- LOUVERED PENTHOUSE - LIGHTING
ADJ AFF	- ADJUSTABLE - ABOVE FINISHED FLOOR	LWT	- LEAVING WATER TEMPERATURE
AHU AL	- AIR HANDLING UNIT - ALUMINUM	MAU MAX	- MAKE-UP AIR UNIT - MAXIMUM
ALT AMD	- ALTERNATE - AIR MIXING DEVICE	MBH MC	- THOUSANDS OF BTU PER HOUR - MECHANICAL CONTRACTOR
AP APD	- ACCESS PANEL - AIR PRESSURE DROP	MCA MCC	- MINIMUM CIRCUIT AMPACITY - MOTOR CONTROL CENTER
APPROX ARCH		MCC MEP	- MOTOR CONTROL CENTER - MECHANICAL, ELECTRICAL AND PLUMB
ARU AS	- AIR ROTATION UNIT - AIR SEPARATOR	MER MEZZ	- MECHANICAL EQUIPMENT ROOM - MEZZANINE
AT AVG	- AIR TERMINAL DEVICE - AVERAGE	MFR MIN.	- MANUFACTURER - MINIMUM
7.00		MISC. MOD	- MISCELLANEOUS - MOTOR OPERATED DAMPER
B BAS BBS	<ul><li>BOILER</li><li>BUILDING AUTOMATION SYSTEM</li><li>BOILER BLOWDOWN SEPARATOR</li></ul>	NA	- NOT APPLICABLE
BC BFS	- BOOSTER COIL - BOILER FEEDWATER SYSTEM	NC NIC	- NOT ALT EICABLE - NORMALLY CLOSED - NOT IN CONTRACT
BOB	- BOTTOM OF BEAM	NO	- NORMALLY OPEN
BOD BOP	- BOTTOM OF DUCT - BOTTOM OF PIPE	NPS NPSH	- NOMINAL PIPE SIZE - NET POSITIVE SUCTION HEAD
BTU BTUH	<ul><li>BRITISH THERMAL UNITS</li><li>BRITISH THERMAL UNITS PER HOUR</li></ul>	NPT NR	- NATIONAL PIPE THREAD - NEAR
C	- CONVECTOR	NTS	- NOT TO SCALE
CAV CC	<ul><li>CONSTANT AIR VOLUME</li><li>COOLING COIL</li></ul>	OC OED	<ul><li>ON CENTER</li><li>OPEN END DUCT</li></ul>
CFH CFM	- CUBIC FEET PER HOUR - CUBIC FEET PER MINUTE	OLP OV	- OVERLOAD PROTECTION - OUTLET VELOCITY
CH CL	- CHILLER - CENTERLINE	P	- PUMP
CLG COND	- CEILING - CONDENSATE	PC PCF	- PLUMBING CONTRACTOR - POUNDS PER CUBIC FOOT
CONTR	- CONTRACTOR	PD	- PRESSURE DROP
COP CP	<ul><li>COEFFICIENT OF PERFORMANCE</li><li>CONDENSATE PUMP</li><li>CONDENSATE RETURN UNIT</li></ul>	PH PLBG	- PHASE - PLUMBING - POINT OF CONNECTION
CRU CT	- COOLING TOWER	POC PPH PRV PSF	- POINT OF CONNECTION - POUNDS PER HOUR
CU CUH	<ul><li>COPPER</li><li>CABINET UNIT HEATER</li></ul>	PRV PSF	<ul><li>PRESSURE RELIEF VALVE</li><li>POUNDS PER SQUARE FOOT</li></ul>
DAP	- DUCT ACCESS PANEL	PSI PSIA	<ul><li>POUNDS PER SQUARE INCH</li><li>POUNDS PER SQUARE INCH ABSOLUTE</li></ul>
DB DC	- DRY BULB - DUST COLLECTOR	PSIG PVC	<ul><li>POUNDS PER SQUARE INCH GAUGE</li><li>POLYVINYL CHLORIDE</li></ul>
DDC DEG	<ul><li>DIRECT DIGITAL CONTROL</li><li>DEGREES</li></ul>	RAHU	- ROOFTOP AIR HANDLING UNIT
DH DIA	- DEHUMIDIFIER - DIAMETER	RCP REF	<ul><li>RADIANT CEILING PANEL</li><li>ROOF EXHAUST FAN</li></ul>
DIM DN	- DIMENSION - DOWN	REQD	- REQUIRED - ROOF
DWG DX	- DRAWING - DIRECT EXPANSION	RF RF RH	- RELIEF FAN - RELIEF HOOD
EAT		RH RPM	- RELATIVE HUMIDITY
EBB EC	<ul> <li>ENTERING AIR TEMPERATURE</li> <li>ELECTRIC BASEBOARD</li> <li>ELECTRICAL CONTRACTOR</li> </ul>	RTU RV	- ROOFTOP UNIT
EDR EF	- EQUIVALENT DIRECT RADIATION - EXHAUST FAN	IVV	- ROOF VENTILATOR
EFF	- EFFICIENCY	S/S	- STAINLESS STEEL
EH EJ	- EXHAUST HOOD - EXPANSION JOINT	SA SCH	<ul><li>SOUND ATTENUATOR</li><li>SCHEDULE</li></ul>
ELEC ELEV	- ELECTRICAL - ELEVATION	SF SHT	- SUPPLY FAN - SHEET
EM ESP	<ul><li>EMERGENCY</li><li>EXTERNAL STATIC PRESSURE</li></ul>	SMD SP	<ul><li>SMOKE MOTORIZED DAMPER</li><li>STATIC PRESSURE</li></ul>
ET ETR	<ul><li>EXPANSION TANK</li><li>EXISTING TO REMAIN</li></ul>	SPEC SQ	<ul><li>SPECIFICATION</li><li>SQUARE</li></ul>
EUH EWT	<ul><li>ELECTRIC UNIT HEATER</li><li>ENTERING WATER TEMPERATURE</li></ul>	STD STRUCT	- STANDARD
EXH EXIST	- EXHAUST - EXISTING	T	- TANK
EXP	- EXPANSION	T STAT T&P	- THERMOSTAT - TEMPERATURE AND PRESSURE
F	- FAHRENHEIT	TBR TC	- TO BE REMOVED - TEMPERATURE CONTROL
F F&T	- FILTER - FLOAT AND THERMOSTATIC	TEMP TOB	- TEMPERATURE - TOP OF BEAM
FC FCU	- FORWARD CURVED	TOD TOP	- TOP OF DUCT
FD	- FLOOR DRAIN	TOS	- TOP OF SLAB
FLA FLR	- FULL LOAD AMPS - FLOOR	TSP TXV	- TOTAL STATIC PRESSURE - THERMAL EXPANSION VALVE
FM FOP	- FACTORY MUTUAL - FUEL OIL PUMP	TYP	- TYPICAL
FOT FPD	<ul><li>FUEL OIL TANK</li><li>FLUID PRESSURE DROP</li></ul>	UC	- UNDERCUT DOOR
FPI FPM	<ul><li>FINS PER INCH</li><li>FEET PER MINUTE</li></ul>	UH UNO	<ul><li>UNIT HEATER</li><li>UNLESS OTHERWISE NOTED</li></ul>
FPS FT	- FEET PER SECOND - FEET	UST UV	<ul><li>UNDERGROUND STORAGE TANK</li><li>UNIT VENTILATOR</li></ul>
FTG FTR	- FOOTING - FIN TUBE RADIATION	V	- VOLTS
GA	- GAUGE	V VA	- VALVE - VALVE
GAL GALV	- GALLON - GALVANIZED	VAV VEL	- VARIABLE AIR VOLUME - VELOCITY
GBD GC	- GRAVITY BACKDRAFT DAMPER - GENERAL CONTRACTOR	VEL VF VFD	VELOGITI     VENTILATION FAN     VARIABLE FREQUENCY DRIVE
GF GPH	- GAS FURNACE	VFD VP VP	- VELOCITY PRESSURE
GPH GPM GV	<ul><li>GALLONS PER HOUR</li><li>GALLONS PER MINUTE</li><li>GRAVITY VENTILATOR</li></ul>	VP VTR	- VACUUM PUMP - VENT THRU ROOF
Н	- HUMIDIFIER	W/	- WITH
HC HP	- HEATING COIL - HEAT PUMP	W/O WB	- WITHOUT - WET BULB
HP HRC	- HORSEPOWER - HEAT RECOVERY COIL	WC WG	- WATER COLUMN - WATER GAUGE
HRD HX	- HEAT RECLAIM DEVICE - HEAT EXCHANGER	Х	- EXISTING
	- INTAKE AIR HOOD		-
IAH			
IAH ID IF	- INSIDE DIAMETER - INVERT FLEVATION		
	INDICED TO SELECTION		

	PI	PING SYSTEMS		DU	JCT SYSTEMS
CA	-	COMPRESSED AIR	EA	-	EXHAUST AIR
CWS	-	CONDENSER WATER SUPPLY	OA	-	OUTSIDE AIR
CWR	-	CONDENSER WATER RETURN	RA	-	RETURN AIR
CHWS	-	CHILLED WATER SUPPLY	SA	-	SUPPLY AIR
CHWR	-	CHILLED WATER RETURN	TA	-	TRANSFER AIF
D	-	DRAIN LINE			
PW	-	POTABLE WATER			
FOF	-	FUEL OIL FILL			
FOS	-	FUEL OIL SUPPLY			
FOR	-	FUEL OIL RETURN			
FOV	-	FUEL OIL VENT			
HPS	-	HEAT PUMP WATER SUPPLY			
HPR	-	HEAT PUMP WATER RETURN			
HWS	-	HOT WATER SUPPLY			
HWR	-	HOT WATER RETURN			
HPS	-	HIGH PRESSURE STEAM			
HPC	-	HIGH PRESSURE STEAM CONDENSATE			
HS	-	HYDRONIC SUPPLY (DUAL TEMPERATURE SYSTEM)			
HR	-	HYDRONIC RETURN (DUAL TEMPERATURE SYSTEM)			
LPS	-	LOW PRESSURE STEAM			
LPC	-	LOW PRESSURE STEAM CONDENSATE			
NG	-	NATURAL GAS			
NPW	-	NON-POTABLE WATER			
PC	-	PUMPED CONDENSATE			
RHG	-	REFRIGERANT HOT GAS			
RL	-	REFRIGERANT LIQUID			
RS	-	REFRIGERANT SUCTION			
V	-	VENT LINE			

	GRILLE, REGISTER, AN	D DIFFUSER	NOTATION
FIRST FIGU	E DIMENSION) RE: SIDE SHOWN GURE: SIDE NOT SHOWN  AIRFLOW (CFM)	CD-A 200	GRD TAG (SEE SCHEDULE SHEET FOR FURTHER INFORMATION)  TYPICAL DESIGNATIONS: CEILING SUPPLY DIFFUSER (CD) SUPPLY GRILLE (SG) LINEAR SLOT (LS) RETURN GRILLE (RG) EXHAUST GRILLE (EG) TRANSFER GRILLE (TG) SUPPLY REGISTER (SR)  (SEE SCHEDULE FOR NECK SIZE)
			Г
	- RECTANGULAR SUPPLY GRILLE, REGISTER, OR DIFFUSER (HORIZONTAL MOUNT)		- SUPPLY GRILLE, REGISTER, OR DIFFU (VERTICAL MOUNT)
	REGISTER, OR DIFFUSER (HORIZONTAL	<b>→</b>	
	REGISTER, OR DIFFUSER (HORIZONTAL MOUNT)  - ROUND SUPPLY GRILLE, REGISTER, OR		(VERTICAL MOUNT)  - RETURN OR EXHAUST GRILLE OR

	MECHANICAL DUCT	WORK SPEC	IALT	TIES
	- MANUAL VOLUME DAMPER	F/S	-	COMBINATION FIRE/SMOKE DAMPER
M	- MOTORIZED DAMPER		-	DUCT ACCESS DOOR
B	- BACKDRAFT DAMPER		-	FLEX DUCT (DOUBLE & SINGLE LINE)
FD	- FIRE DAMPER		-	IN-DUCT HEATING / COOLING COIL
	- SMOKE DAMPER	<u> </u>	-	LINED DUCTWORK

	GENERAL SYMBOLS
#	- REVISION CLOUD WITH TAG
####	- VIEW CALLOUT
# ####	- SECTION VIEW
DETAIL / PAGE #	- VIEW REFERENCE
<b></b>	- ELEVATION MARKER
•	- POINT OF CONNECTION
	- POINT OF DISCONNECTION
# #	- KEYED NOTE - HEXAGON = NEW CONSTRUCTION - CIRCLE = DEMOLITION
VAV-1	- MECHANICAL EQUIPMENT TAG
TAG ——► TAG ——●	- PIPE OR DUCT TAG
	- PIPING, DUCTWORK, EQUIPMENT, DEVICES, ETC. TO BE DEMOLISHED
	- EXISTING PIPING, DUCTWORK, OR EQUIPMENT TO REMAIN
	- NEW PIPING, DUCTWORK, OR EQUIPMENT
~~	- BREAK LINE
<-/r>	- AIRFLOW DIRECTION ARROW
<b>→</b>	- FLOW DIRECTION ARROW

	DUCTWORK FITTINGS & SYMBOLS	
<b>}</b>	RECTANGULAR / ROUND BRANCH TAKEOFF	
<b>-</b>	TEE (FOR LOW PRESSURE SUPPLY AIR DUCTWORK ONLY)	
<b>}</b>	ECCENTRIC TRANSITION	
<b>\</b>	CONCENTRIC TRANSITION	
<b></b>	SUPPLY AIR OR OUTSIDE AIR RISE	<b>X</b>
<del></del>	SUPPLY AIR OR OUTSIDE AIR DROP	<b>X</b>
<b>-</b>	RETURN AIR RISE	<b> </b>
<del></del>	RETURN AIR DROP	<u> </u>
<b></b>	EXHAUST AIR RISE	<b>\</b>
<del></del>	EXHAUST AIR DROP	<b>}</b>
	RADIUS ELBOW	
}	SQUARE ELBOW	
	DUCT CROSSING	
<b>├</b>	DUCT SLOPE IN DIRECTION OF RISE	

7	- BALANCING VALVE		- PIPE ELBOW DOWN
	BILINOING VILVE		THE ELBOW BOWN
	- BALL VALVE		- PIPE ELBOW UP
	- BUTTERFLY VALVE		- PIPE TEE DOWN
Z.	- BUTTERFLY VALVE WITH ACTUATOR	-0-	- PIPE TEE UP
	- CHECK VALVE	1   1	- PIPE UNION
<b>Б</b> -1	- DRAIN VALVE WITH CAPPED END	AV	- AUTOMATIC AIR VENT
	- GATE VALVE	- HMV	- MANUAL AIR VENT
	- GLOBE VALVE		- BALL JOINT
	- ISOLATION (SHUTOFF) VALVE	EJ	- EXPANSION JOINT
	- PIPE STRAINER		- FLEX CONNECTION
### PSI	- PRESSURE REDUCING VALVE	FM	- FLOW METER
### PSI	- PRESSURE RELIEF VALVE	FS	- FLOW SWITCH
	- PUMP	4	- PETES PLUG
	- TRIPLE DUTY VALVE		- PRESSURE GAUGE
	- 2-WAY CONTROL VALVE	PS	- PRESSURE SWITCH
	- 3-WAY CONTROL VALVE	⊗ <sub>xx</sub>	- STEAM TRAP (XX) IB = INVERTED BUCKET T = THERMOSTATIC T&B = FLOAT AND THERMOSTATIC
_]	- CAPPED PIPE		- THERMOMETER
F	- FLOW SENSOR	T	- TEMPERATURE SENSOR

	MECHANICA	L CONTROLS	
T <sub>##-###</sub>	- SPACE THERMOSTAT/TEMPERATURE SENSOR WITH ASSOCIATED EQUIPMENT TAG	CO	- CARBON MONOXIDE SENSOR
H	- SPACE HUMIDISTAT	(CO <sub>2</sub> )	- CARBON DIOXIDE SENSOR
P	- PRESSURE SENSOR	NO <sub>2</sub>	- NITROGEN DIOXIDE SENSOR
SD	- DUCT SMOKE DETECTOR		
S	- SPEED SWITCH		
S	- STARTER		

	VII	EW ORG	ANIZATIC	N	
D1	D2	D3	D4	D5	D6
C1	C2	C3	C4	C5	C6
B1	B2	В3	B4	B5	В6
A1	A2	A3	A4	A5	A6

	MECHANICAL SHEET INDEX
M-001	MECHANICAL SYMBOLS AND ABBREVIATIONS
M-002	MECHANICAL NOTES AND SCHEDULES
M-101	UNDERGROUND LEVEL A MECHANICAL FLOOR PLAN
M-102	STREET LEVEL C MECHANICAL FLOOR PLAN



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214 N Carroll St Madison, WI 53703

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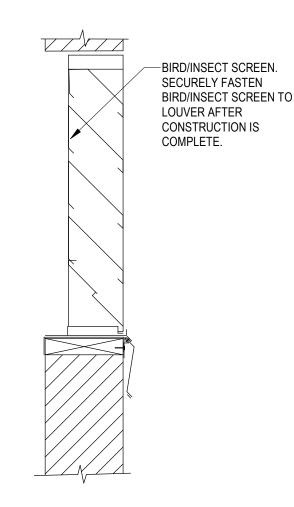
MECHANICAL SYMBOLS AND

ABBREVIATIONS

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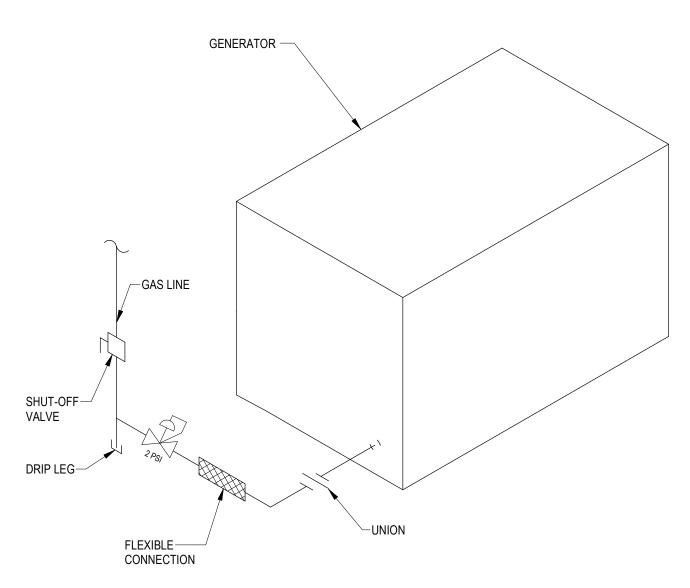
M-001

		LOUVER (WPL) SCHEDULE										
Ī	NOTES:											
Ī	PROVIDE INTERNALLY MOUNTED INSECT SCREEN.											
	TAG WPL-1		SERVICE	WIDTH	HEIGHT	DEPTH	FREE AREA (SF)	MODEL	MANUFACTURER	NOTES		
			101 - GENERATOR ROOM	48"	48"	4"	7.00	FDS-402	GREENHECK	1		



1. SEAL ALL CORNERS AND SEAMS WATERTIGHT USING SEALANT AND OR SOLDERING. REFER TO SPECIFICATION SECTION 23 31 00 FOR ACCEPTABLE SEALANTS.





NATURAL GAS CONNECTION TO EQUIPMENT

### **GENERAL PROJECT NOTES**

- ALL WORK SHALL COMPLY WITH THE WISCONSIN BUILDING CODE AND ALL APPLICABLE STANDARDS.
- 2. DIMENSIONS SHALL BE FIELD-VERIFIED AND COORDINATED PRIOR TO PROCUREMENT OR FABRICATION. COORDINATE THE WORK WITH OTHER TRADES INVOLVED. FIELD MODIFICATIONS SUCH AS OFFSETS IN PIPING OR DUCTWORK (INCLUDING DIVIDED DUCTWORK) NEEDED DUE TO OBSTRUCTIONS OR INTERFERENCES SHALL BE PROVIDED AT NO ADDITIONAL COST. FOR PROJECTS INVOLVING RENOVATION, COORDINATE NEW WORK WITH EXISTING ELEMENTS SUCH AS THE BUILDING STRUCTURE AND ARCHITECTURAL FEATURES, SPRINKLER PIPING, LIGHTS, PLUMBING, AND ELECTRICAL CONDUIT.
- DRAWINGS ARE DIAGRAMMATIC IN NATURE. COORDINATE EXACT LOCATION OF ALL CEILING MOUNTED EQUIPMENT SO ALL SERVICEABLE COMPONENTS CAN BE EASILY ACCESSED BY REMOVING CEILING TILES ONLY. REMOVAL OR RELOCATION OF LIGHTING FIXTURES FOR SERVICE ACCESS IS NOT ACCEPTABLE. THE CONTRACTOR SHALL RE-INSTALL EQUIPMENT THAT HAS INADEQUATE OR UNSAFE ACCESSIBILITY. PROVIDE ALL TRANSITIONS. TURNING VANES, ELBOWS, FITTINGS, ETC., TO ALLOW SMOOTH FLOWS. ALL SPLIT DUCT FITTINGS SHALL TRANSITION TO FULL SIZE OF THE SUM OF BOTH BRANCHES, UPSTREAM OF SPLIT. REFER TO TYPICAL DETAILS FOR PIPING AND INSTALLATION OF EQUIPMENT.
- 4. PRIOR TO BID, COORDINATE ALL MECHANICAL WORK WITH ELECTRICAL WORK AND OTHER TRADES. SEE SPECIFICATIONS FOR REQUIREMENTS.
- 5. GENERAL CONTRACTOR IS RESPONSIBLE TO HAVE QUALIFIED SUBCONTRACTORS PERFORMING ALL WORK. CONTRACTORS AND FOREMEN PERFORMING WORK UNDER THIS DIVISION SHALL MEET THE SPECIFIED MINIMUM QUALIFICATIONS AND LICENSE REQUIREMENTS. QUALIFICATIONS SHALL BE SUBMITTED FOR REVIEW BY A/E PRIOR TO SHOP DRAWING PHASE AND PRIOR TO ANY WORK BEING PERFORMED BY CONTRACTOR. NO PAYMENTS WILL BE AUTHORIZED BY ENGINEER FOR WORK PERFORMED BY SUBCONTRACTING FIRMS OR FOREMEN THAT DO NOT MEET THE MINIMUM QUALIFICATIONS.
- WHERE CROWDED LOCATIONS EXIST OR WHERE THERE IS A POSSIBILITY OF CONFLICT BETWEEN TRADES, CONTRACTOR SHALL PREPARE COMPOSITE DRAWINGS SHOWING THE EXACT LOCATION OF PIPES, DUCTS, CONDUIT AND EQUIPMENT. DRAWINGS SHALL BE BASED ON FIELD MEASUREMENTS AND, AFTER CONSULTATION AND AGREEMENT BETWEEN THE TRADES, SHALL BE APPROVED BY THE ARCHITECT/ENGINEER BEFORE INSTALLATION OF THE
- MECHANICAL CONTRACTOR SHALL COORDINATE WITH ENGINEER AND GENERAL CONTRACTOR ON REQUIREMENTS FOR STRUCTURAL SUPPORT AND FRAMING FOR ALL MECHANICAL EQUIPMENT AND SYSTEMS. GENERAL CONTRACTOR SHALL BE RESPONSIBLE FOR PROVIDING AND VERIFYING STRUCTURAL SUPPORT AND FRAMING.
- MECHANICAL CONTRACTOR SHALL BE RESPONSIBLE FOR FIELD VERIFICATION OF EXISTING CONDITIONS AND COORDINATION WITH ALL OTHER TRADES, INCLUDING BUT NOT LIMITED TO STRUCTURAL, LIGHTING, ELECTRICAL, PLUMBING, AND OTHER EXISTING AND NEW WORK. VERIFY ALL EXISTING CONDITIONS IN FIELD PRIOR TO PURCHASING EQUIPMENT. ALL DISCREPANCIES OR POTENTIAL PROBLEMS SHALL BE BROUGHT TO THE ATTENTION OF THE ENGINEER PRIOR TO BIDDING. PROVIDE ADDITIONAL MATERIALS AND LABOR TO RELOCATE OR REPLACE MECHANICAL WORK AS REQUIRED TO ALLOW SPACE FOR THE WORK OF ALL TRADES.
- 9. THE DRAWINGS INDICATE APPROXIMATE LOCATIONS BASED UPON INFORMATION OBTAINED WITHOUT REMOVING CEILING TILES OR WALLS. THEREFORE, THE CONTRACTOR SHALL INCLUDE IN THEIR BID CONTINGENCY COSTS TO ADDRESS CONFLICTS BETWEEN DESIGN AND EXISTING CONDITIONS.
- 10. THE CONTRACTOR SHALL BE RESPONSIBLE FOR ALL COSTS INCURRED BY OTHER TRADES DUE TO SUBSTITUTION OF OTHER THAN SCHEDULED EQUIPMENT. WHEN EQUIPMENT FURNISHED IS DIFFERENT THAN INDICATED, THE COST OF ADDITIONAL ELECTRICAL SERVICE, STRUCTURAL AND RELATED WORK SHALL BE PAID BY THIS CONTRACTOR.
- 11. ALL SERVICES TO EXISTING BUILDINGS SHALL BE MAINTAINED DURING CONSTRUCTION UNLESS OTHERWISE INDICATED. IF NECESSARY, INTERRUPTIONS TO EXISTING SERVICES SHALL BE SCHEDULED FOR TIMES OTHER THAN NORMAL OPERATING HOURS (SUCH AS NIGHTS AND WEEKENDS). SUCH INTERRUPTIONS TO SERVICES SHALL NOT BE MADE WITHOUT THE PRIOR WRITTEN CONSENT OF THE OWNER'S REPRESENTATIVE AND PROPER COORDINATION WITH OTHER TRADES. PRE-WORK SHALL BE PERFORMED TO MAKE THE SHUTDOWN PERIOD AS BRIEF AS POSSIBLE.
- 12. ALL CHANGES MADE IN THE FIELD SHALL BE RECORDED ON AS-BUILT DRAWINGS, SHOP DRAWINGS, AND MAINTENANCE MANUALS. NOTIFY ENGINEER OF ANY CONFLICTS PRIOR TO PURCHASING EQUIPMENT AND PRIOR TO CUTTING OPENINGS.
- 13. SHOP DRAWINGS SHALL BE SUBMITTED AND REVIEWED FOR ALL MECHANICAL WORK INCLUDING, BUT NOT LIMITED TO, DUCTWORK, PIPING, EQUIPMENT, AND AIR DISTRIBUTION DEVICES PRIOR TO ANY FABRICATION OR INSTALLATION. ALL SHOP DRAWINGS SHALL BE SUBMITTED IN A FORMAT THAT IS IN STRICT ACCORDANCE WITH SPECIFICATIONS.
- 14. LOCATE EQUIPMENT TO ACHIEVE MANUFACTURER'S RECOMMENDED ACCESS AND CLEARANCE FOR OPERATION AND MAINTENANCE. COORDINATE EQUIPMENT LOCATIONS WITH WORK OF OTHER TRADES. DO NOT INFRINGE ON THE OPERATION AND MAINTENANCE SPACES OF EQUIPMENT INSTALLED BY OTHER TRADES. WHERE CONFLICT OCCURS, COORDINATE WITH OTHER TRADES TO LOCATE OR RELOCATE EQUIPMENT TO RESOLVE CONFLICT AND MAINTAIN REQUIRED ACCESS.
- 15. ALL CONNECTIONS TO EQUIPMENT SHALL BE VERIFIED WITH MANUFACTURER'S CERTIFIED DRAWINGS. TRANSITIONS TO ALL EQUIPMENT SHALL BE VERIFIED AND PROVIDED FOR EQUIPMENT FURNISHED.
- 16. ALL EQUIPMENT, PIPING AND VALVES SHALL HAVE SPECIFIED IDENTIFICATION LABELS AND AS INDICATED.
- 17. DUCT OPENING TYPES THROUGH BUILDING CONSTRUCTION SHALL BE SUITED TO PRESERVE FLOOR, WALL, OR DUCT/PIPE SYSTEM RATINGS.
- 18. COORDINATE DUCTWORK WITH EXISTING CEILING SUPPORT CABLES.
- 19. DUCT CONSTRUCTION SHALL BE SHEET METAL AND IN ACCORDANCE WITH THE LATEST EDITION OF THE SAUNA HVAC DUCT CONSTRUCTION STANDARD. DUCT SIZES SHOWN ARE MINIMUM INSIDE CLEAR DIMENSIONS.
- 20. ALL SUPPLY AIR DUCT BENDS FROM THE VERTICAL TO THE HORIZONTAL AND ANGLED TURNS OF DUCTWORK SHALL BE RADIUS ELBOWS. WHERE A RADIUS ELBOW WILL NOT FIT, ELBOW SHALL HAVE TURNING VANES INSTALLED.
- 21. BEVELED TAKE-OFFS AND DAMPERS SHALL BE INSTALLED IN ALL BRANCH DUCTWORK LEADING FROM MAIN TRUNK LINES.
- 22. COORDINATE DIFFUSER, GRILLE AND REGISTER LOCATIONS WITH ARCHITECTURAL REFLECTED CEILING PLANS AND EQUIPMENT OF ALL TRADES. VERIFY FINISH WITH ARCHITECT PRIOR TO PURCHASING GRILLES, REGISTERS, DIFFUSERS, LOUVERS AND OTHER AIR DISTRIBUTION DEVICES.
- 23. PROVIDE AIR TURNING VANES IN ALL 90-DEGREE RECTANGULAR DUCT ELBOWS.
- 24. SEE SPECIFICATIONS FOR GAUGES, THICKNESS, BRACING, REQUIREMENTS, ETC., OF DUCTWORK.
- 25. LOCATE THERMOSTATS, TEMPERATURE SENSORS, HUMIDISTATS, AND HUMIDITY SENSORS AT 48" ABOVE FINISHED FLOOR UNLESS NOTED OTHERWISE. COORDINATE LOCATIONS WITH OTHER EQUIPMENT, FURNITURE, AND DOOR SWINGS.
- 26. ALL EQUIPMENT, DUCTWORK, ETC., SHALL BE SUPPORTED AS DETAILED AND/OR SPECIFIED. PROVIDE ADDITIONAL SUPPORTS AS REQUIRED TO PROVIDE A VIBRATION-FREE, RIGID INSTALLATION.
- 27. ALL BARE METAL SURFACES SHALL BE PRIMED TO PREVENT ANY RUST, INCLUDING, BUT NOT LIMITED TO, ANGLE FRAMING, UNIT SUPPORTS, MOUNTING HARDWARE, ETC. DAMPERS AND INSIDES OF DUCTS VISIBLE THROUGH GRILLES, REGISTERS AND DIFFUSERS SHALL BE PAINTED FLAT BLACK.
- 28. ACCESS PANELS IN DUCTWORK AND CEILINGS SHALL BE PROVIDED WHERE REQUIRED FOR OPERATION, BALANCING OR MAINTENANCE OF ALL
- MECHANICAL EQUIPMENT. PROVIDE ACCESS PANELS AS REQUIRED FOR ALL VALVES, DAMPERS, CONTROLS, OR OTHER EQUIPMENT. 29. PROVIDE FLEXIBLE DUCT CONNECTIONS ON ALL DUCTWORK CONNECTING TO EACH FAN, AIR HANDLING UNITS, AND FAN COIL UNITS.
- 30. LOCATE ALL OUTSIDE AIR INTAKES A MINIMUM OF 10'-0" CLEAR FROM ALL PLUMBING VENTS AND EXHAUST AIR DISCHARGE LOCATIONS. LOWEST POINT OF EACH OUTSIDE AIR INTAKE ON ROOF SHALL BE A MINIMUM OF 24" ABOVE ROOF.
- 31. PIPING, DUCTWORK, LEAK PROTECTION APPARATUS, OR OTHER EQUIPMENT FOREIGN TO ELECTRICAL SWITCHBOARDS, PANELBOARDS, DISTRIBUTION BOARDS, OR MOTOR CONTROL CENTERS SHALL NOT BE INSTALLED WITHIN THE REQUIRED SPACE FOR WORKING CLEARANCES OR DEDICATED SPACES OF THE ELECTRICAL EQUIPMENT, EXTENDING IN FRONT OF AND FROM FLOOR TO STRUCTURAL CEILING WITH A WIDTH AND DEPTH OF THE ELECTRICAL EQUIPMENT IN ACCORDANCE WITH NEC-110.26.
- 32. GENERAL DEMOLITION NOTE: INFORMATION TAKEN FROM AVAILABLE RECORD DRAWINGS AND VISUAL FIELD OBSERVATIONS. CONTRACTOR SHALL FIELD VERIFY ALL EXISTING CONDITIONS PRIOR TO COMMENCEMENT OF WORK.
- 33. ALL EQUIPMENT, DUCTWORK, ETC., TO BE REMOVED SHALL REMAIN PROPERTY OF THE OWNER OR DISPOSED OF LEGALLY, AS DIRECTED BY OWNER.

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CLIENT:

CITY OF MADISON



Madison Municipal Building 215 Martin Luther King Blvd Suite 109 Madison, Wisconsin 53703

PROJECT TITLE:

STATE STREET CAPITOL GARAGE GENERATOR REPLACEMENT

214 N Carroll St

B Madison, WI 53703

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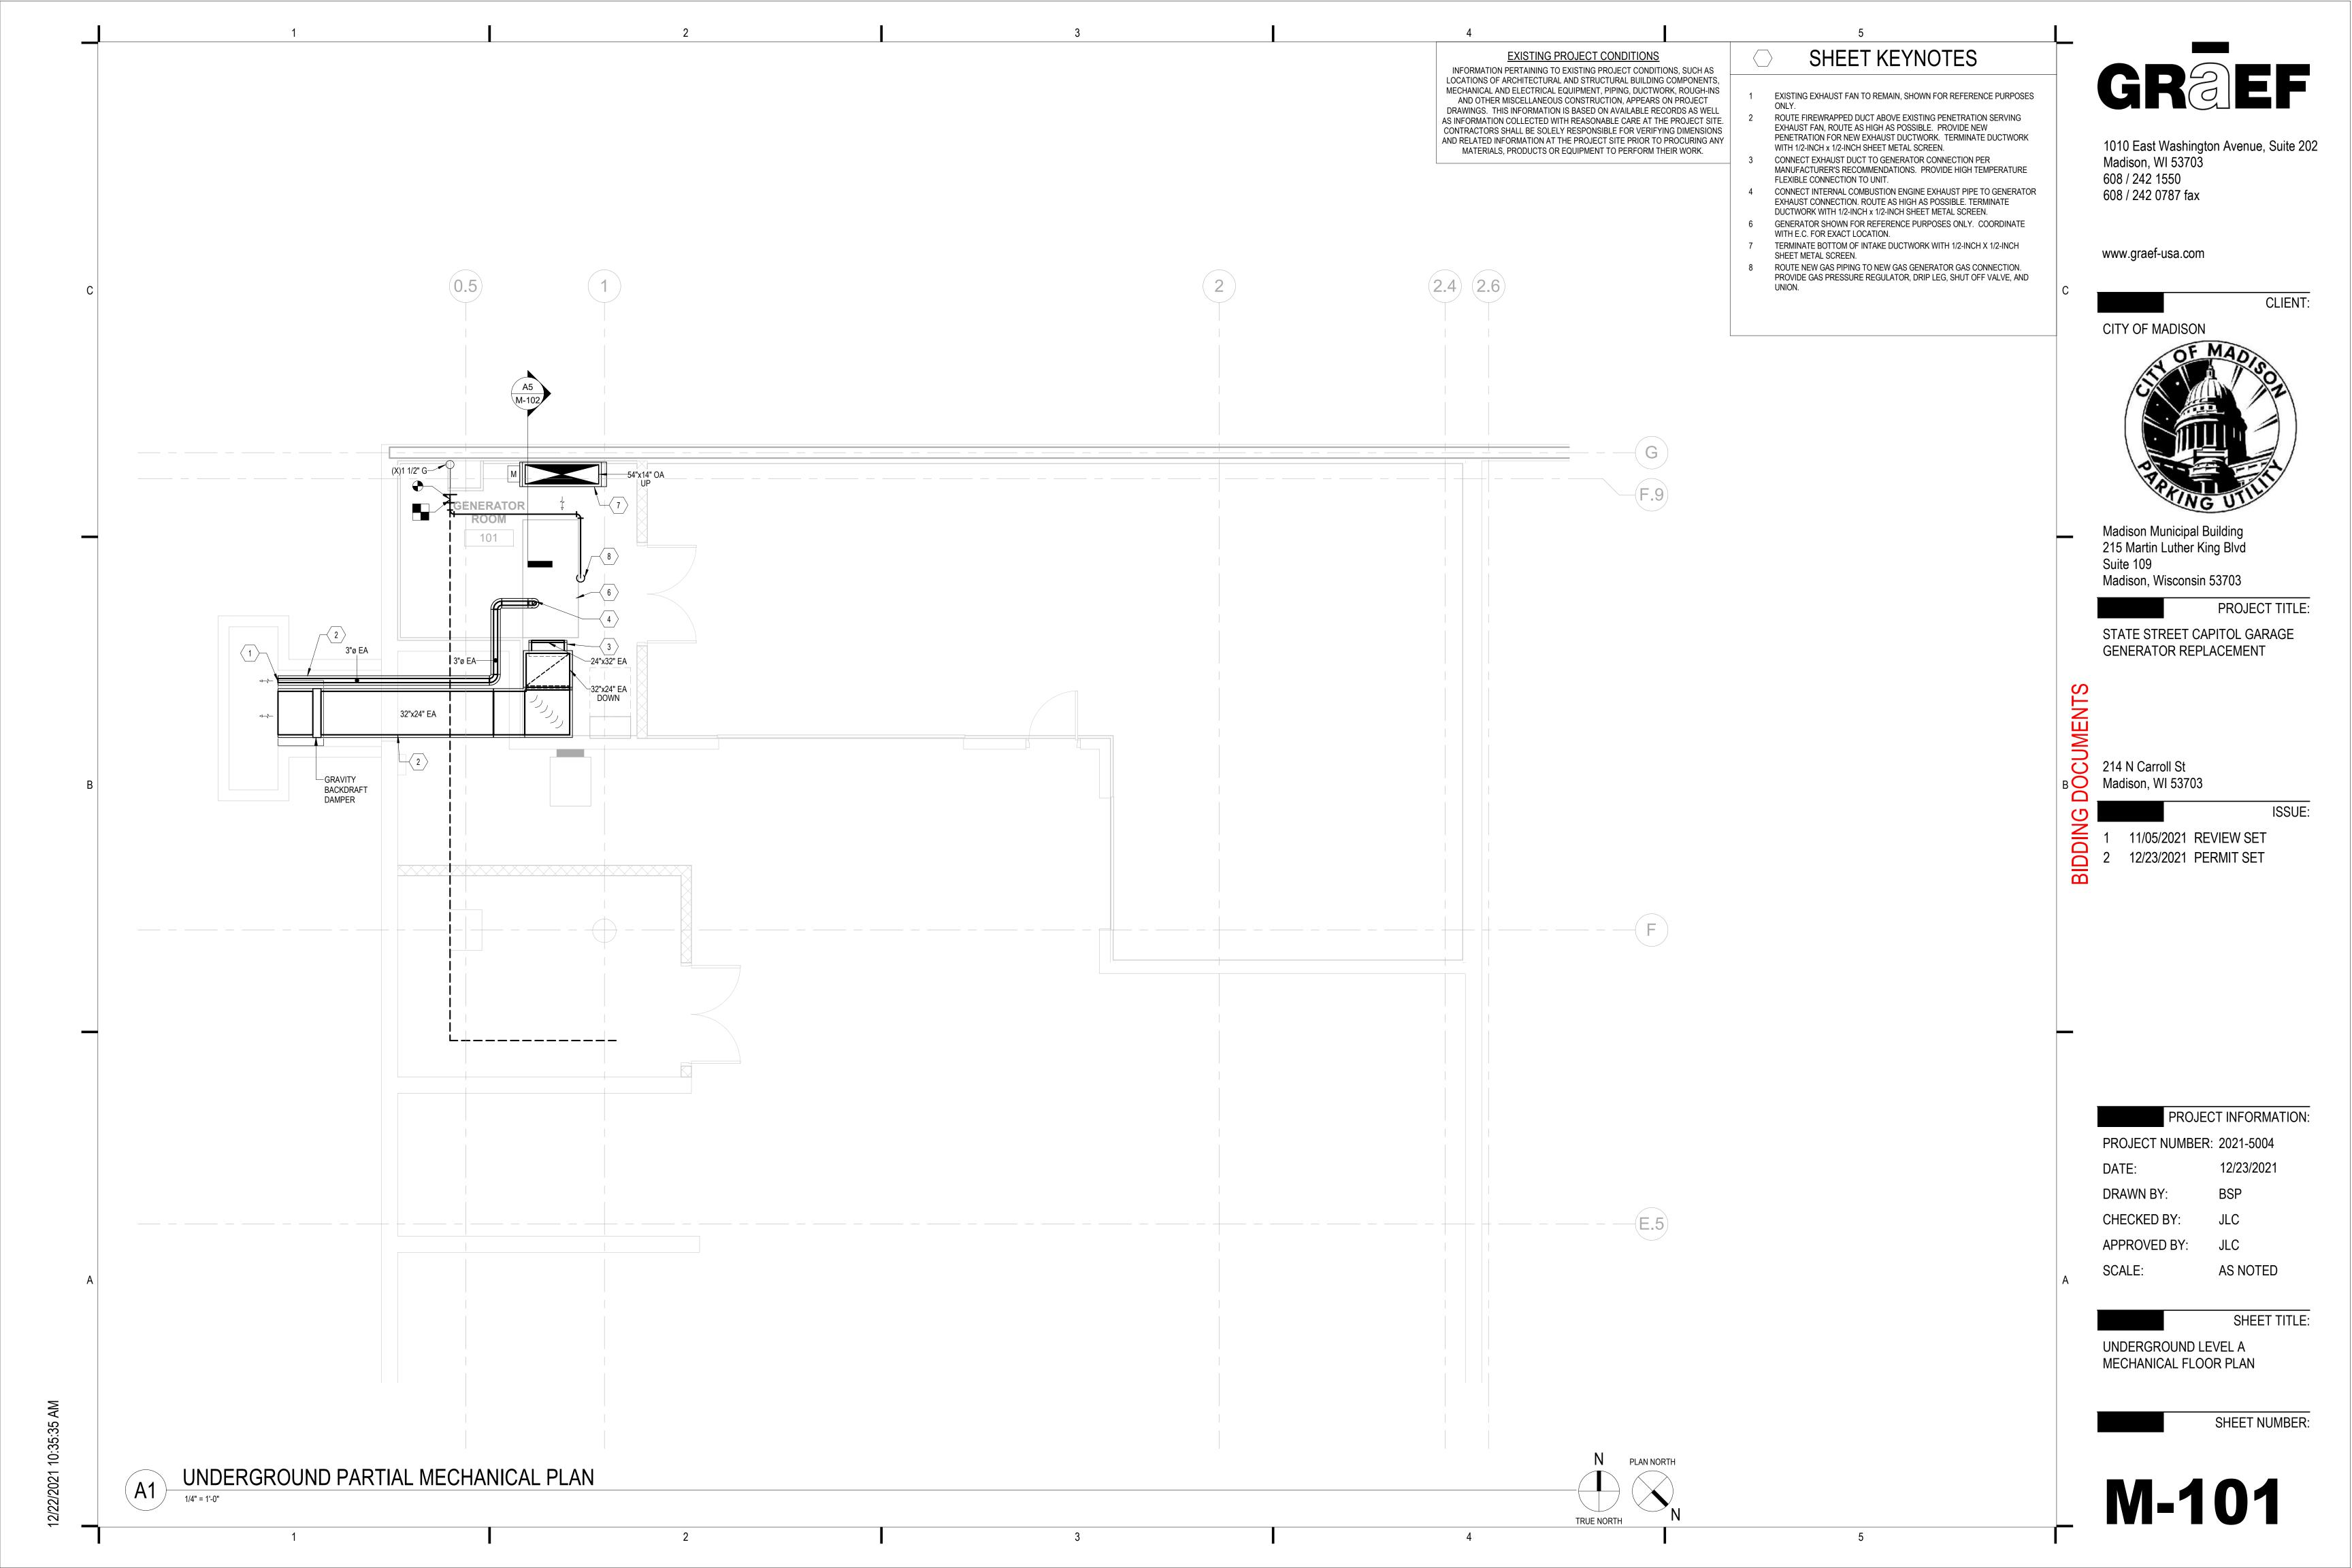
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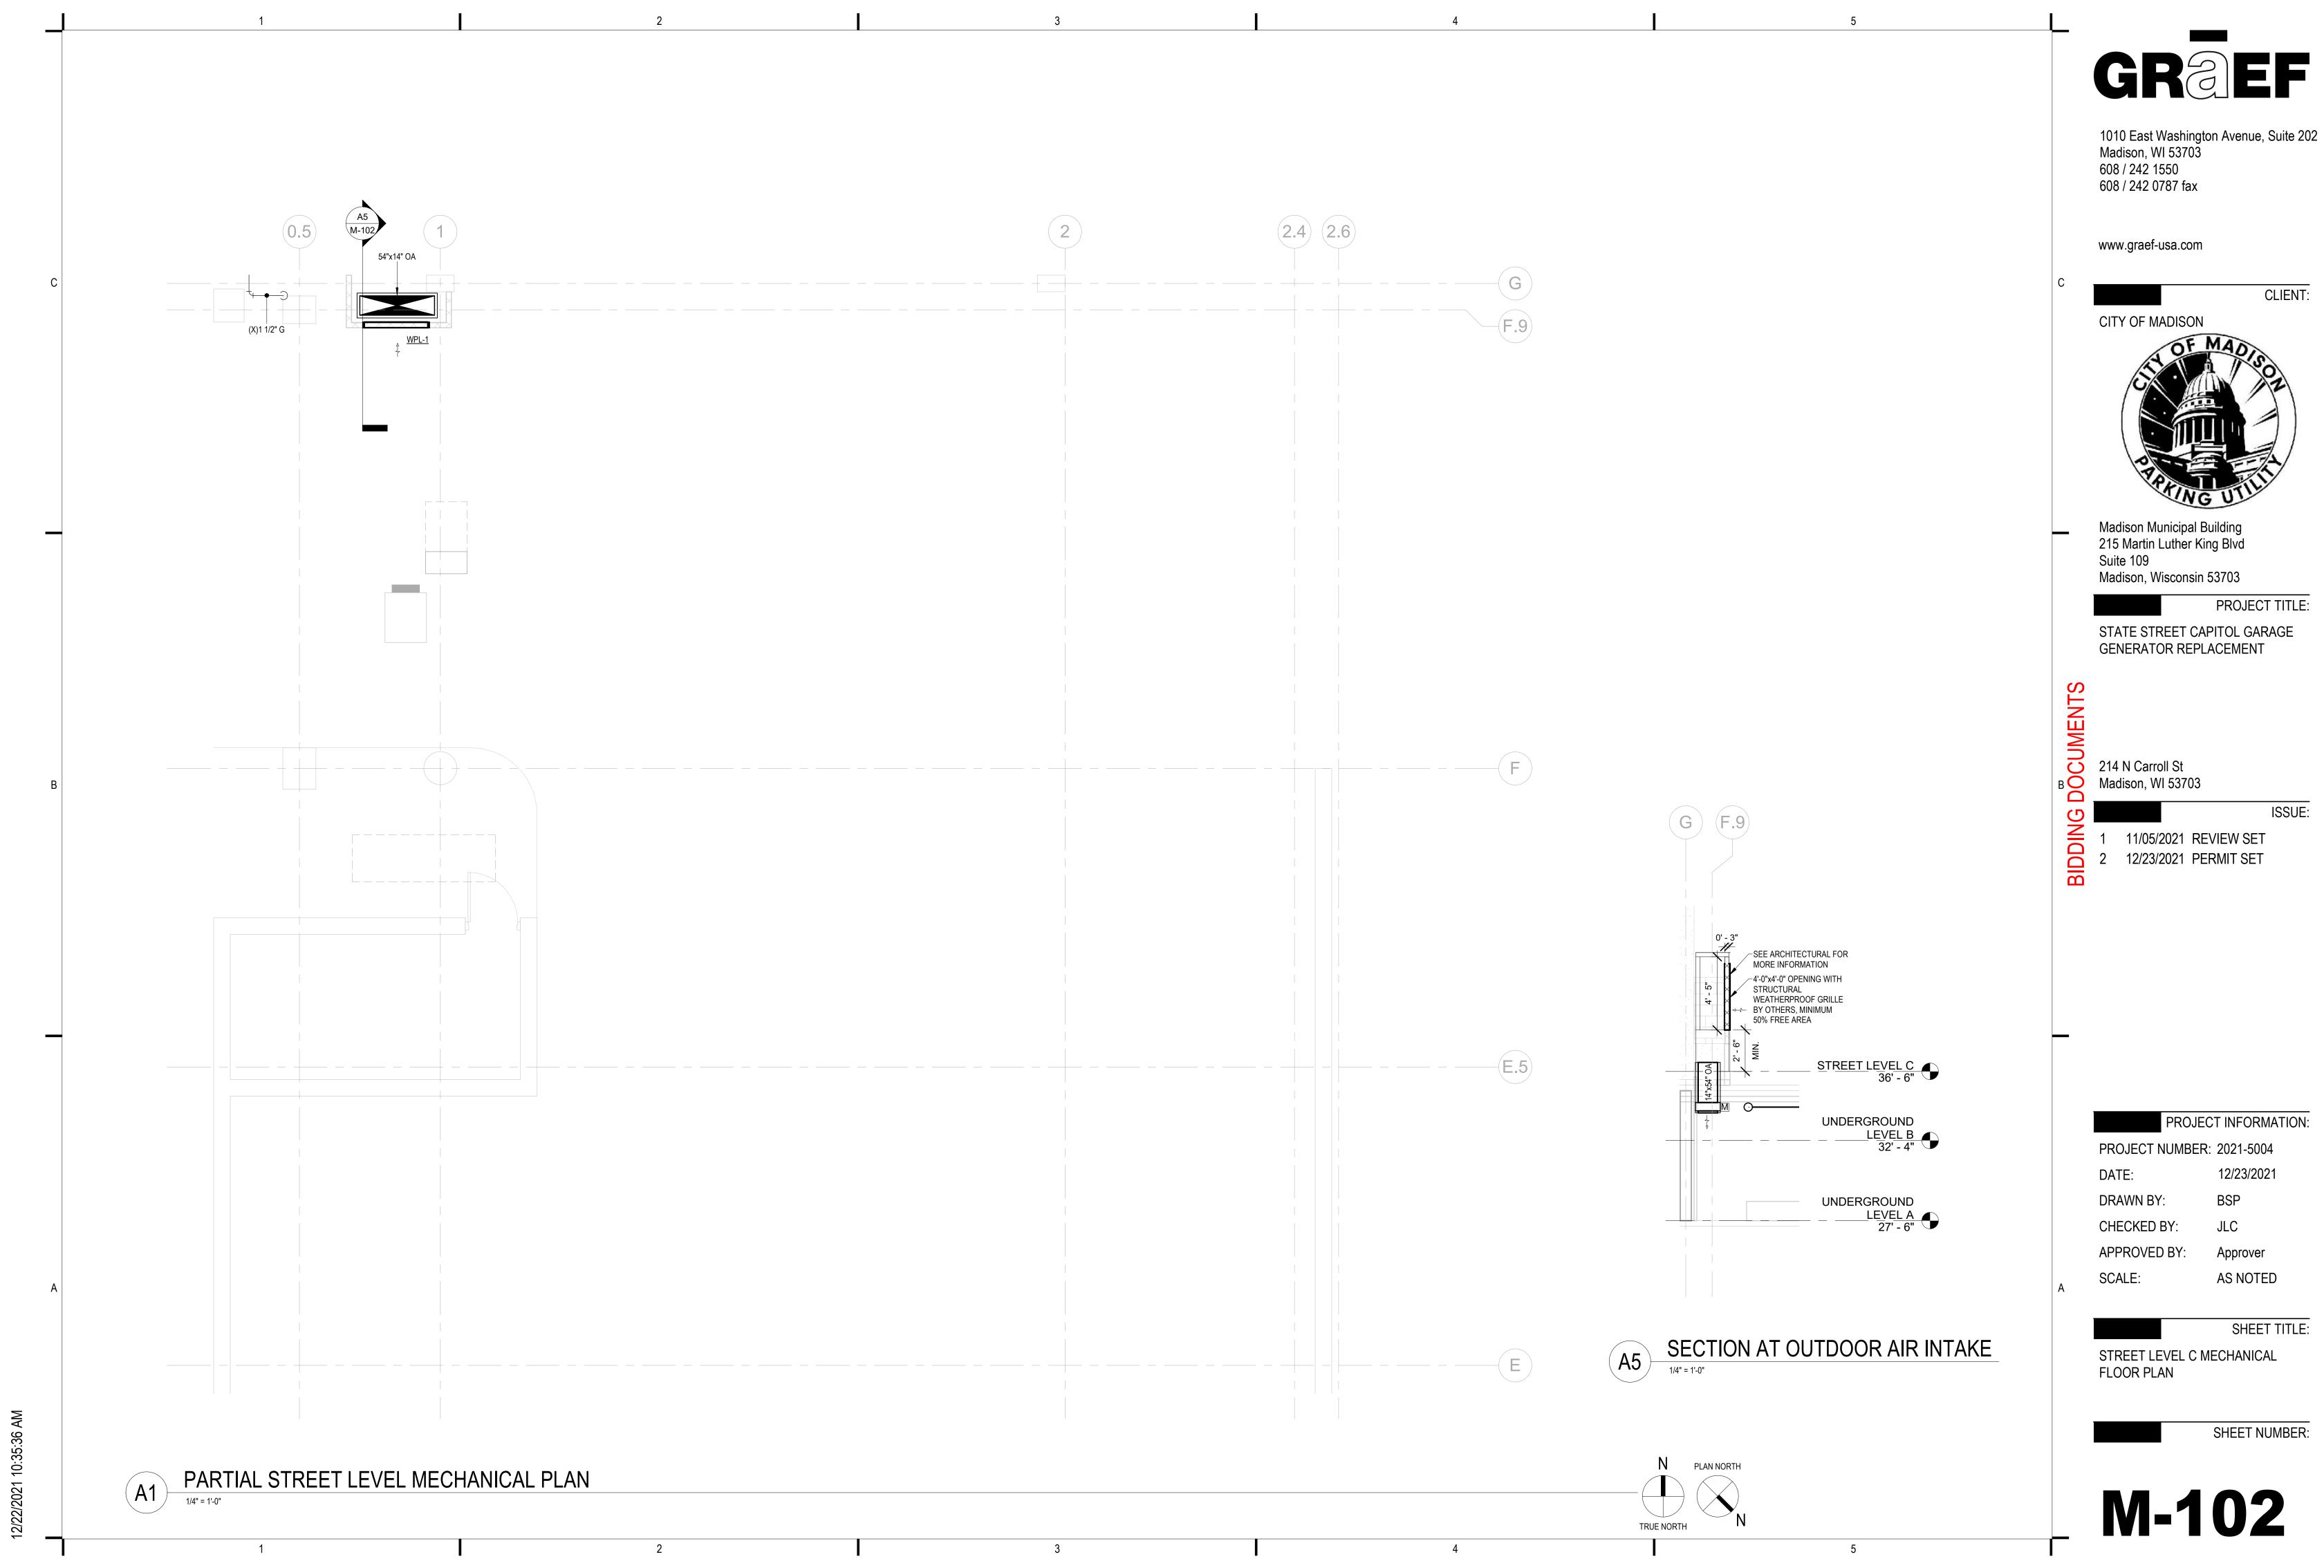
SCALE: AS NOTED

SHEET TITLE:

MECHANICAL NOTES AND SCHEDULES

SHEET NUMBER





GREF

1010 East Washington Avenue, Suite 202

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STATE STREET CAPITOL GARAGE

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11/05/2021 REVIEW SET

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ABBREVIATIONS & SHEET INDEX

SHEET NUMBER

### **GENERAL NOTES**

- CONTRACT.
- ESSENTIALLY TO REMAIN UNCHANGED. ALTHOUGH THIS DESIGNATION IN A GIVEN ROOM REFERS TO THE STATUS OF BASIC ELECTRICAL DEVICES, THERE MAY BE SOME DEMOLITION WORK REQUIRED INVOLVING BACK-FEEDING EXISTING CIRCUITS, REMOVING CIRCUITS THAT ARE DE-ENERGIZED DUE TO DEMOLITION IN OTHER ROOMS, OR OTHER NECESSARY MODIFICATIONS, SEE ALL DOCUMENTS THAT MAKE UP THIS CONTRACT FOR THE TOTAL EXTENT OF WORK REQUIRED IN ALL SPACES.

### KEYED NOTES THIS SHEET

- (1) DEMOLISH EXISTING FEED TO EXISTING GENERATOR. EC TO
- LOCATION.

- 1. ALL ELECTRICAL EQUIPMENT SHOWN ON THIS DEMOLITION PLAN IS "EXISTING TO BE REMOVED" UNLESS NOTED OTHERWISE. IN ADDITION TO REMOVING DEVICES, REMOVE ALL ABANDONED ELECTRICAL CIRCUITS BACK TO THEIR SOURCE. REFER TO THE SPECIFICATIONS FOR ADDITIONAL ELECTRICAL DEMOLITION REQUIREMENTS.
- 2. IN GENERAL, DASHED WALLS ON THIS PLAN INDICATE EXISTING WALLS BEING DEMOLISHED. DO NOT RELY SOLELY ON ELECTRICAL DRAWINGS TO DETERMINE EXTENT OF GENERAL CONSTRUCTION DEMOLITION. REFER TO ARCHITECTURAL DEMOLITION PLANS FOR THE EXACT EXTENT OF GENERAL CONSTRUCTION DEMOLITION REQUIRED BY THIS CONTRACT.
- 3. REFER TO DEMOLITION DRAWINGS OF OTHER TRADES. WHERE MOTORS, CONTROL PANELS, AND OTHER LOADS THAT HAVE AN ELECTRICAL CONNECTION ARE BEING REMOVED, INCLUDE THE DISCONNECTION AND REMOVAL OF ASSOCIATED ELECTRICAL FEEDS, CIRCUITS, AND LOOSE CONTROL EQUIPMENT IN THIS
- 4. ROOMS IDENTIFIED WITH "ETR", (EXISTING TO REMAIN) ARE

- COORDINATE WITH GC THE TRANSPORTATION OF THE EXISTING GENERATOR TO THE OVERTURE CENTER GARAGE AS DIRECTED BY
- 2 RELOCATE EXISTING LIGHT FIXTURE. SEE SHEET E-400 FOR NEW

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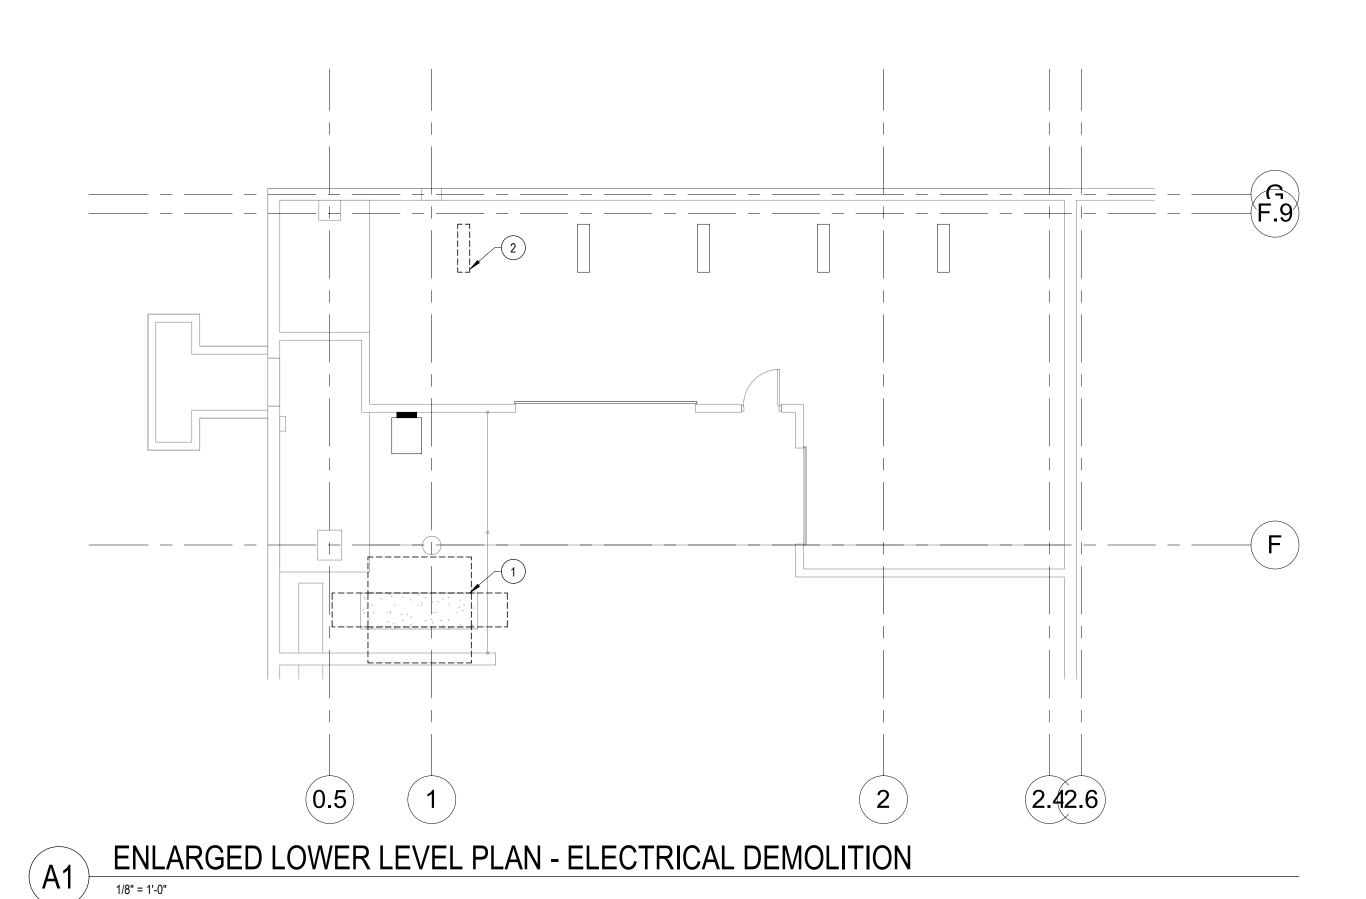
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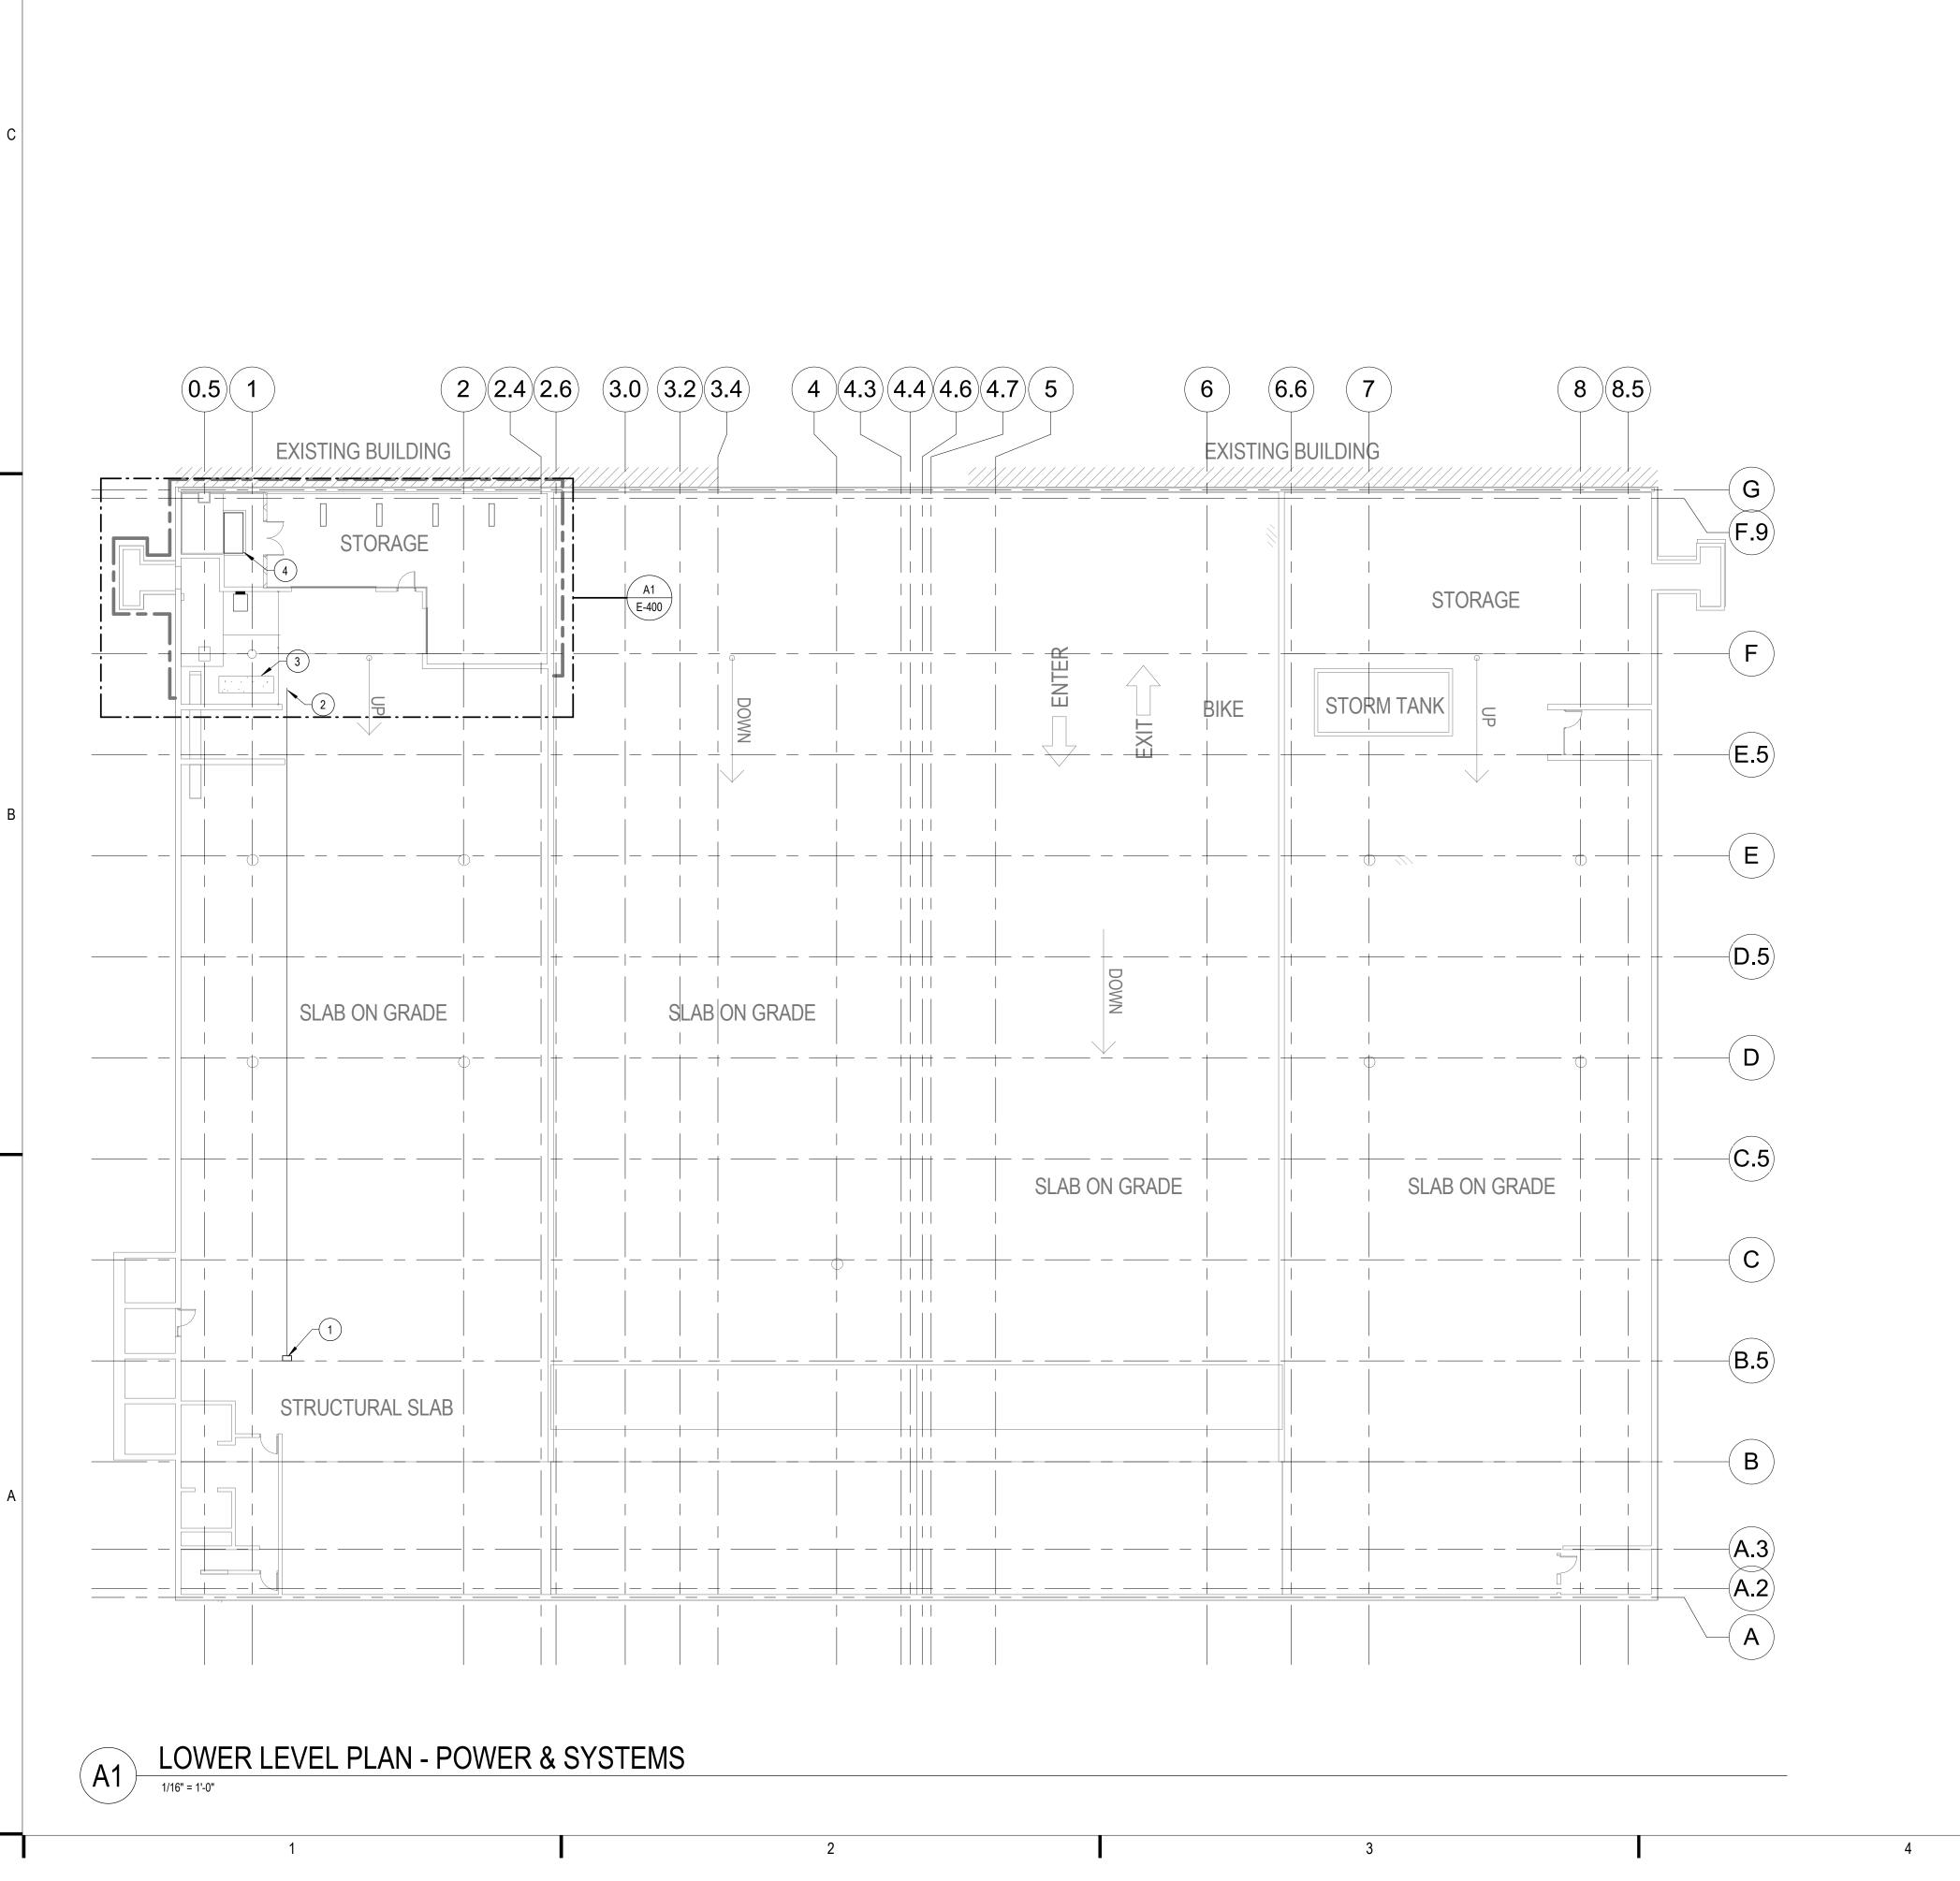
SHEET TITLE:

ENLARGED LOWER LEVEL PLAN -ELECTRICAL DEMOLITION

SHEET NUMBER:

ED-101





### KEYED NOTES THIS SHEET

- 1 APPROXIMATE LOCATION OF EXISTING ATS/EM AND EXISTING MAIN SWITCHBOARD. ATS/EM IS LOCATED IN ELECTRICAL ROOM NEAR THE MAIN SWITCHBOARD.
- 2 REUSE EXISTING CONDUIT UP TO PULL BOX LOCATED HERE. AFTER THIS POINT PROVIDE NEW CONUIT. PROVIDE NEW FEEDER ENTIRE RUN SEE ONE LINE DIAGRAM FOR MORE INFORMATION.
- (3) EXISTING LOCATION OF EXISTING GENERATOR.
- 4 LOCATION OF NEW GENERATOR.

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APPROVED BY: DW

SCALE: AS NOTED

SHEET TITLE:

LOWER LEVEL PLAN - OVERALL

SHEET NUMBER:

KEYED NOTES THIS SHEET

- 1 NEW GENEATOR EG/A SEE ONE LINE DIAGRAM ON SHEET E-701 FOR MORE INFORMATION.
- 2 RELOCATED EXISTING LIGHT FIXTURE FROM SHEET ED-101.
  CONNECT THIS LIGHT AND NEW A1 LIGHT FIXTURE TO EXISITNG CIRCUIT.
- 3 NEW ATS/M SEE ONE LINE DIAGRAM ON SHEET E-701 FOR MORE INFORMATION.

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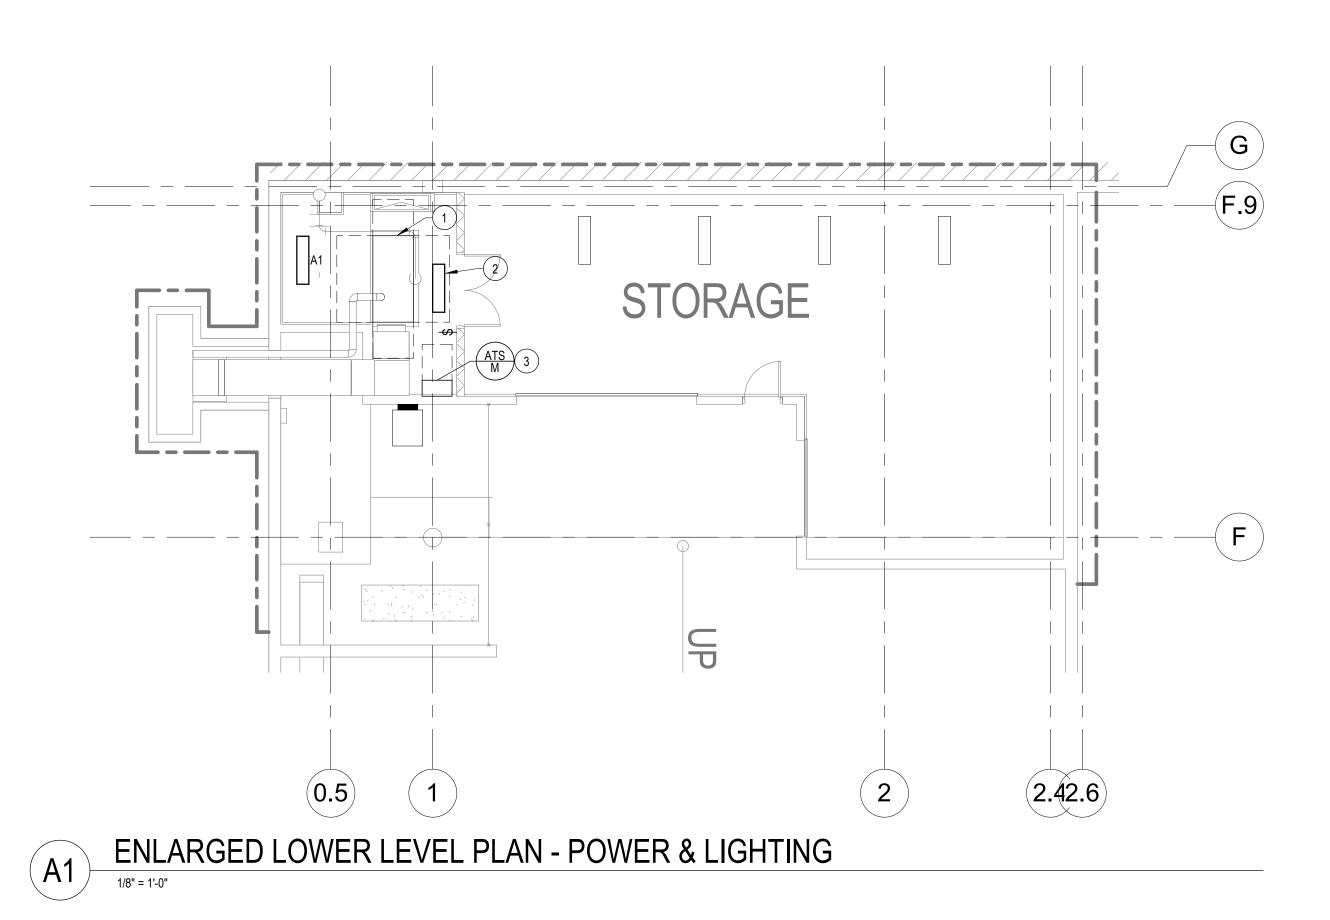
APPROVED BY:

SCALE: AS NOTED

SHEET TITLE:

**ENLARGED PLANS** 

SHEET NUMBER:



### LIGHT FIXTURE SCHEDULE

### **GENERAL NOTES:**

A. SEE SPECIFICATION SECTION FOR ADDITIONAL INFORMATION REGARDING FIXTURE AND INSTALLATION REQUIREMENTS.

B. MANUFACTURERS LISTED AS ACCEPTABLE SHALL MEET ALL REQUIREMENTS AND FEATURES INDICATED. ACCEPTABLE MANUFACTURERS MUST MEET THE PHOTOMETRIC PERFORMANCE OF THE LISTED UNIT. ELECTRICAL CONTRACTOR SHALL ENSURE THE FIXTURE DEPTH / HEIGHT WILL COMPLY WITH ADA REQUIREMENTS AND WILL NOT INTERFERE WITH OTHER TRADES WITHIN THE CEILING CAVITY.

C. ELECTRICAL CONTRACTOR SHALL COORDINATE T-GRID, WOOD AND SPECIALTY CEILING SYSTEMS WITH ARCHITECT PRIOR TO ORDERING.

D. ELECTRICAL CONTRACTOR SHALL PROVIDE ALL REQUIRED PARTS AND PIECES FOR A COMPLETE INSTALLATION.

E. ALL REMOTE DRIVERS SHALL BE LOCATED IN AN ACCESSIBLE LOCATION THAT MEETS THE AMBIENT TEMPERATURE REQUIREMENTS OF THE DRIVER. ELECTRICAL CONTRACTOR SHALL VERIFY WITH SUBMITTED SHOP DRAWING WIRING DIAGRAMS THAT ALL DRIVER...

### NOTES:

L														
		PERFORMANCE & ELECTRICAL DATA					LIGHT FIXTURE PROPERTIES				MOUNTING			
TAG	TAG	LUMENS	KELVIN TEMP	LOAD	FIXTURE VOLTAGE	DESCRIPTION	MANUFACTURER	CATALOG SERIES	DEPTH OR HEIGHT	MATERIAL	TYPE	HEIGHT	HEIGHT TO	SEE NOTE
	A1	4000	4000	35 VA		4' LED WRAPAROUND	LA LIGHTING	3 WSE200 4K 4L TP WL 1 DRDM UNV 1 840	0' - 6"					

### LIGHT FIXTURE SCHEDULE ABBREVIATIONS

NOTE: NOT ALL ABBREVIATIONS INDICATED HERE ARE USED IN THE SCHDULE AND MAY NOT APPLY TO CURRENT PROJECT.

**MOUNTING MATERIAL** 

B = BRICK C = CONCRETE CB = CONCRETE BASE

V = VARIES

W = WOOD

DW = DRYWALL ES = EXPOSED STRUCTURE G = GROUND LG = LAY-IN GRID M = METALPL = PLASTER S = STONE T = TILE

**MOUNTING TYPE** C = COVE

CH = CHAIN - PROVIDE ACCESSORY KIT CA = CATENARY MP = MONOPOINT MPC = MULTIPORT CANOPY PC = PENDANT - CABLE PCH = PENDANT - CHAIN PRS = PENDANT - RIGID STEM PS = PENDANT - SWAG PO = POLE R = RECESSED S = SURFACE

TC = TRACK - CABLE
TMC = TRACK - MONORAIL - CURVED
TMF = TRACK - MONORAIL - FLEXIBLE TMS = TRACK - MONORAIL - STRAIGHT W = WALL

SENSOR TYPE

P = PHOTOCELL

D = DAYLIGHT SENSOR MO = MULTI-LEVEL OCCUPANCY SENSOR N = NONE O = OCCUPANCY SENSOR

1010 East Washington Avenue, Suite 202 Madison, WI 53703 608 / 242 1550 608 / 242 0787 fax

www.graef-usa.com

CLIENT:

CITY OF MADISON



Madison Municipal Building 215 Martin Luther King Blvd Suite 109

Madison, Wisconsin 53703

PROJECT TITLE:

STATE STREET CAPITOL GARAGE GENERATOR REPLACEMENT

214 N Carroll St Madison, WI 53703

1 11/05/2021 REVIEW SET 2 12/23/2021 PERMIT SET

PROJECT INFORMATION:

PROJECT NUMBER: 2021-5004 12/23/2021 DATE:

DRAWN BY:

CHECKED BY:

APPROVED BY:

AS NOTED SCALE:

SHEET TITLE: ELECTRICAL SCHEDULES

SHEET NUMBER:

### ONE LINE DIAGRAM SYMBOLS

XDISCONNECT SWITCH SIZE AS INDICATED ON DRAWINGS - (X) INDICATES TYPE:

(NONE) NON-FUSED (F) FUSED (CB) CIRCUIT BREAKER

MANUAL MOTOR STARTER

- (X) INDICATES MOTOR CONTROLLED MAGNETIC MOTOR STARTER - (X) INDICATES MOTOR CONTROLLED

MAGNETIC MOTOR STARTER AND DISCONNECT COMBINATION - (X) INDICATES MOTOR CONTROLLED

> VARIABLE FREQUENCY DRIVE - (X) INDICATES MOTOR CONTROLLED

TRANSFER SWITCH

KIRK KEY INTERLOCK SYSTEM

GROUND CONNECTION TO SYSTEM AND / OR EQUIPMENT LIGHTNING ARRESTER WITH GROUND CONNECTION TO PROTECT ALL PHASES

 $\rightarrow$ POTHEAD

STRESS CONE **--W-** RESISTOR

CAPACITOR PANELBOARD - TOP DESIGNATES XXX PANELBOARD TYPE XXX - BOTTOM DESIGNATES

> CIRCUIT BREAKER - (XA) INDICATES TRIP SIZE - (XP) INDICATES NUMBER OF POLES

PANELBOARD ID

CIRCUIT BREAKER - PRIMARY DRAW OUT

CIRCUIT BREAKER - LOW VOLTAGE DRAW OUT - (XAF) INDICATES FRAME SIZE

MOTOR OPERATOR FOR CIRCUIT BREAKERS OR SWITCHES

- FUSED CUTOUT SWITCH

CONTACT - NORMALLY OPEN

CONTACT

- (XA) INDICATES RATING

GROUND FAULT

TRANSFORMER

TRANSFORMER - POTENTIAL

EMERGENCY POWER OFF

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STATE STREET CAPITOL GARAGE GENERATOR REPLACEMENT

DÖCUMENT

G

BIDDIN

214 N Carroll St

Madison, WI 53703

1 11/05/2021 REVIEW SET

2 12/23/2021 PERMIT SET

- (XAF) INDICATES FRAME SIZE - (XAT) INDICATES TRIP SIZE

- (XAT) INDICATES TRIP SIZE

SHUNT TRIP

SWITCH

- UN-FUSED CUTOUT

- NORMALLY CLOSED

OVERLOAD RELAY

GENERATOR

- DRY TYPE, UOI IDENTIFICATION

> TRANSFORMER - CURRENT

DRAWN BY: CHECKED BY:

APPROVED BY:

DATE:

PROJECT NUMBER: 2021-5004

ELECTRICAL ONE-LINE POWER DIAGRAM

SHEET NUMBER:

PROJECT INFORMATION:

12/23/2021

AS NOTED

SHEET TITLE:

GB

DW

E-701

ONE-LINE POWER DIAGRAM